AC-001 N AC-100 F AC-102 S AD-101 F AD-102 S	COVER SHEET MOUNTING HEIGHTS FIRST FLOOR EGRESS PLAN SECOND FLOOR EGRESS PLAN	CONSTRUCTION DOCUMENTS 10-14-2016	ADDENDUM #2 11.30.2016		
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AD-101 F AD-102 S	SECOND FLOOR EGRESS PLAN	•			
AD-102 S		•			
	FIRST FLOOR DEMOLITION PLAN	•	•		
	SECOND FLOOR DEMOLITION PLAN	•	•		
AD-201 F		•	•		
	FIRST FLOOR RESTROOM DEMOLITION REFLECTED CEILING PLANS		-		
AD-202 S	SECOND FLOOR RESTROOM DEMOLITION REFLECTED CEILING PLANS	•	•		
A-101 F	FIRST FLOOR PLAN	•	•		
A-102 S	SECOND FLOOR PLAN	•	•		
	FIRST FLOOR FINISH PLAN	•	•		
A-112 S	SECOND FLOOR FINISH PLAN	•	•		
A-201 F	FIRST FLOOR REFLECTED CEILING PLAN	•	•		
A-202 S	SECOND FLOOR REFLECTED CEILING PLAN	•	•		
	NTERIOR ELEVATIONS	•	•		
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	NTERIOR ELEVATIONS	-	-		
A-602	NTERIOR ELEVATIONS	•	•		
A-603	NTERIOR ELEVATIONS	•	•		
	NTERIOR ELEVATIONS	•	•		
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A-910 F	FINISH SCHEDULE	•			
A-911 F	FINISH SCHEDULE	•			
MECHANICAL					
M-001	MECHANICAL SPECIFICATIONS, LEGEND, SYMBOLS & ABBREVIATIONS	•			
M-002	MECHANICAL SCHEDULES & DETAILS	•			
MD-100	MECHANICAL DEMOLITION PLANS	•			
M-100	MECHANICAL BOARDWALK LEVEL NEW WORK PLANS	•			
		•			
	MECHANICAL CONCOURSE LEVEL NEW WORK PLANS				
M-102	MECHANICAL CONCOURSE LEVEL NEW WORK PLANS	•			
PLUMBING					
P-000 F	PLUMBING LEGEND, NOTES & SCHEDULES	•			
		•			
	FIRST & SECOND FLOOR OVERALL DEMOLITION LOCATION PLANS				
PD-101 F	FIRST FLOOR RESTROOM DEMOLITION PLANS	•			
PD-102 S	SECOND FLOOR RESTROOM DEMOLITION PLANS	•			
P-100 F	FIRST & SECOND FLOOR OVERALL NEW WORK LOCATION PLANS PLUMBING	•			
	FIRST FLOOR RESTROOM NEW WORK PLANS PLUMBING	•			
	SECOND FLOOR RESTROOM NEW WORK PLANS PLUMBING	•			
P-200 F	PLUMBING DETAILS & RISER DIAGRAMS	•			
FIRE PROTECTION					
FP-000 F	FIRE PROTECTION LEGEND, NOTES & DETAILS	•			
	FIRST & SECOND FLOOR OVERALL NEW WORK LOCATION PLANS FIRE PROTECTION	•			
FP-101 F	FIRST & SECOND FLOOR RESTROOM NEW WORK PLANS FIRE PROTECTION	•			
ELECTRICAL					
E-001 E	ELECTRICAL SHEET SPECIFICATIONS	•	•		
	ELECTRICAL LEGEND & GENERAL NOTES	•	•		
		•	•		
– I D	PARTIAL ELECTRICAL FIRST FLOOR PLANS		-		
		•	•		
	PARTIAL ELECTRICAL SECOND FLOOR PLANS				
E-101 F	PARTIAL ELECTRICAL SECOND FLOOR PLANS		•	i	t

DRAWING LIST

SCALE N.T.S.

SCALE N.T.S.

6

THE SCOPE OF THIS PROJECT IS TO INCLUDE, BUT IS NOT LIMITED TO: THE DEMOLITION OF THE EXISTING RESTROOMS & REPLACEMENT OF FIXTURES, PARTITIONS, MILLWORK, FINISHES, INCLUDING PLUMBING, HEATING, & ELECTRICAL SYSTEMS. THIS PROJECT QUALIFIES AS A "RECONSTRUCTION," PER THE REHABILITATION SUBCODE. ALL WORK MUST COMPLY WITH THE AFOREMENTIONED GOVERNING CODES AS OUTLINED IN THE CODE REVIEW SECTION OF THESE CONSTRUCTION

DOCUMENTS. THESE DOCUMENTS ARE SUBJECT TO MODIFICATION AS NECESSARY TO MEET CODE REQUIREMENTS OR TO FACILITATE STRUCTURAL, MECHANICAL, PLUMBING AND ELECTRICAL INSTALLATIONS, OR INCORPORATE ARCHITECTURAL DESIGN IMPROVEMENTS.

ATLANTIC CITY BOARDWALK HALL


	RK SHALL BE PERFORMED IN STRICT ACCORDANCE WITH THE CODES OUTLINED IN THE CODE REVIEW PORTION OF THE CONSTRUCTION DOCUMENTS APPLICABLE LOCAL CODES, ORDINANCES AND REGULATIONS HAVING JURISDICTION, AS STATED IN THE CODE ANALYSIS.
	SCALE THE DRAWINGS, USE CALCULATED DIMENSIONS ONLY. SCALES INDICATED REFER TO SHEETS PRINTED AT 30"x42" (INCHES) SIZE AND ARE NO BLE TO REDUCED DRAWINGS.
ALL DIM	ENSIONS INDICATED ON THESE DRAWINGS OF EXISTING CONDITIONS ARE APPROXIMATE AND SHALL BE FIELD VERIFIED TO THE SATISFACTION OF T CTOR PRIOR TO THE WORK COMMENCING.
ACTUAL	CONTRACTOR'S RESPONSIBILITY TO FIELD CHECK ALL DIMENSIONS AND FIXTURES AND NOT TO DEVIATE FROM THESE DESIGNS AND TO DETERMINI CONSTRUCTION DETAILS AND FABRICATE IN ACCORDANCE WITH ACCEPTABLE STANDARDS OF PRACTICE AND PROCEDURES. ANY DEVIATION FROM ESIGNS SHALL BE REPORTED TO THE ARCHITECT.
FOR THE THE PRE	NTRACTOR SHALL PROVIDE PROTECTION FOR THE GENERAL PUBLIC AND CONSTRUCTION WORKERS IN AND AROUND THE CONSTRUCTION AREA, AN ADJACENT PROPERTY AND PERSONS. THE CONTRACTOR SHALL PROVIDE ADEQUATE BARRIERS TO EXERCISE CONTROL OF SAFE INGRESS AND EGRES MISES. FIRE EXITS SHALL BE MAINTAINED AT ALL TIMES, AND AT NO TIME BE BLOCKED. THE CONTRACTOR SHALL BARRICADE ALL UNSAFE OR US CONDITIONS.
THE CON ARCHITE	NTRACTOR SHALL CHECK AND VERIFY THE EXISTING CONDITIONS AT THE SITE AGAINST THE DRAWINGS AND SPECIFICATIONS, AND INFORM THE CT IMMEDIATELY OF ANY DISCREPANCIES PRIOR TO COMMENCEMENT OF WORK. CTOR SHALL LAY OUT ALL WALLS, FLOOR PENETRATIONS, ETC. FOR OWNER AND ARCHITECT TO REVIEW AND APPROVE PRIOR TO COMMENCEMENT
CONSTR WORK, A	UCTION. AT TIMES, MAY BE CONDUCTED IN A BUILDING OPERATED AND OCCUPIED BY THE OWNER AND THEIR AGENTS CONCURRENTLY. ALL DEMOLITION AN UCTION OPERATIONS WILL BE COORDINATED WITH THE OWNER PRIOR TO COMMENCEMENT. CONTRACTOR SHALL NOTIFY THE OWNER WITH A
MINIMU ALL EXIS	M FIVE (5) BUSINESS DAYS' NOTICE OF ANY DEMOLITION ACTIVITIES, UTILITY SHUT DOWNS OR DELIVERIES. TING FACILITIES, UTILITIES, AND EQUIPMENT SHALL BE PROTECTED BY THE CONTRACTOR DURING THE ENTIRE PERFORMANCE OF THE WORK. AREA
ALL EXIS DISTURE	ED OR DAMAGED BY THE CONTRACTOR SHALL BE REPAIRED AND/OR REPLACED BY THE CONTRACTOR AT NO ADDITIONAL COST TO THE OWNER. TING FACILITIES, UTILITIES, AND EQUIPMENT SHALL BE PROTECTED BY THE CONTRACTOR DURING THE ENTIRE DURATION OF THE PROJECT. AREAS ED OR DAMAGED BY THE CONTRACTOR SHALL BE REPAIRED AND/OR REPLACED BY THE CONTRACTOR AT NO ADDITIONAL COST TO THE OWNER. ITRACTOR SHALL BE RESPONSIBLE FOR RECORD KEEPING ALL EXPOSED CONDITIONS DISCOVERED DURING THE WORK AND ALL AS-BUILT CONDITION
	NTRACTOR SHALL BE RESPONSIBLE FOR THE INTEGRITY OF THE EXISTING STRUCTURE DURING THE CONSTRUCTION PERIOD AND SHALL TAKE ALL ARY MEASURES TO PREVENT ANY DAMAGE TO THE STRUCTURE, ITS OCCUPANTS AND ITS CONTENTS.
WORK, 1	ITRACTOR SHALL PROVIDE ALL NECESSARY SHORING AND BRACING TO SUPPORT CONSTRUCTION UNTIL PERMANENT SUPPORT IS ERECTED FOR THE THE CONTRACTOR SHALL TAKE ALL NECESSARY MEASURE TO PREVENT COLLAPSE OF WALLS, SLABS, ETC.
OF, AWA	AY FROM THE PREMISES. NO ON-SITE STORAGE OR BURIAL OF DEBRIS SHALL BE ALLOWED.
ALL DEC AND SH	CTORS AND THEIR SUBSEQUENT CONTRACTORS MUST PRESERVE THE INTEGRITY OF THE DESIGN WITHIN PHYSICAL CONDITIONS AND LIMITATIONS. ORATIVE MATERIALS MEETING THE REQUIREMENTS AS STATED IN THE JURISDICTIONAL CODES ARE TO BE NON-COMBUSTIBLE FOR FIRE RESISTANCE ALL COMPLY WITH ALL OTHER GOVERNING CODES AND FIRE SPECIFICATIONS AT THE LOCAL AUTHORITARIAN LEVEL AND BEYOND AS OUTLINED IN T EVIEW SECTION OF THE CONSTRUCTION DOCUMENTS.
LOCATIC	CTRICAL OUTLETS, PLUMBING FIXTURES, MECHANICAL GRILLES, ETC. SHOWN ON THE ARCHITECTURAL DRAWINGS ARE INDICATED TO SET THE GENE IN FOR EACH COMPONENT. THE CONTRACTOR SHALL REFER TO ALL DOCUMENTS, INCLUDING, BUT LIMITED TO, THE MECHANICAL, PLUMBING AND CAL DRAWINGS FOR THE COMPLETE LAYOUT OF EACH RESPECTIVE ITEM.
	/ PIPING AND ELECTRICAL CONDUITS SHALL BE CONCEALED WITHIN NEW CONSTRUCTION UNLESS OTHERWISE NOTED.
	GHOUT THE DURATION OF THE WORK, THE PLUMBING CONTRACTOR SHALL CAP EXISTING SANITARY LINES TO BE RE-UTILIZED.
NOT BE	ICATION OF SUBSTRATE AND THE CONFIGURATION OF CONCEALED ITEMS AND MATERIALS IS FOR GENERAL REFERENCE ONLY. THE CONTRACTOR SE ENTITLED TO ADDITIONAL COMPENSATION FOR ANY VARIANCE BETWEEN ACTUAL EXISTING CONDITIONS AND THAT REPRESENTED ON THE DRAWIN OT INDICATED ON A PART OF THE DRAWINGS, BUT REASONABLY IMPLIED TO BE SIMILAR TO THAT SHOWN AT CORRESPONDING PLACES, SHALL BE
MINOR	ED BY THE CONTRACTOR AT NO ADDITIONAL COST TO THE OWNER. DETAILS OR INCIDENTAL ITEMS NOT USUALLY SHOWN OR SPECIFIED, BUT NECESSARY FOR A PROPER AND COMPLETE INSTALLATION OF ANY PART O RK SHALL BE INCLUDED AS REQUIRED, AS IF THEY WERE INDICATED ON THE DRAWINGS.
ALL ITEN	1S LABELED "EXISTING" ARE EXISTING "TO REMAIN" UNLESS NOTED OTHERWISE. ITEMS NOT LABELED "EXISTING" ARE TO BE PROVIDED.
THE CON	M "PROVIDE" SHALL MEAN FURNISH AND INSTALL, AS IT IS USED THROUGHOUT THE NOTES ON THE DRAWINGS AND IN THE SPECIFICATIONS. ITRACTOR SHALL PROVIDE SEALANT JOINTS BETWEEN ALL DISSIMILAR BUILDING MATERIALS, UNLESS OTHERWISE NOTED. REFER TO SPECIFICATION EDULE OF SEALANTS.
	AND SECTIONS ON THE DRAWINGS ARE SHOWN AT SPECIFIC LOCATIONS, AND ARE INTENDED TO SHOW GENERAL REQUIREMENTS THROUGHOUT. NOTED AS "TYPICAL" IMPLY ALL SIMILAR CONDITIONS ARE TO BE TREATED AS SUCH.
	-RATED CONSTRUCTION SHALL MEET THE FIRE-RESISTIVE RATINGS AND OTHER REQUIREMENTS OF LOCAL LAWS, ORDINANCES, REGULATIONS AND ITIES HAVING JURISDICTION AS OUTLINED IN THE CODE REVIEW SECTION OF THE CONSTRUCTION DOCUMENTS.
CONSTR FIRE ALA	ETRATIONS THROUGH FIRE-RATED CONSTRUCTION SHALL RECEIVE FIRE STOPPING, FIRE DAMPERS, FIRE SAFEING, ETC. TO MAINTAIN THE FIRE-RATE UCTION. SUCH PENETRATIONS SHALL INCLUDE, BUT NOT BE LIMITED TO, TELEPHONE, DATA, LIGHT FIXTURES, JUNCTION BOXES, DUPLEX RECEPTAC RM SYSTEMS, ROOM ACCESSORIES, ETC THE RATING MUST CONTINUE AROUND AND BEHIND THE PENETRATION SO AS TO INSURE THE INTEGRITY SSEMBLY.
THE DO	SURFACE DOOR CLOSURE ARE REQUIRED, THE CONTRACTOR SHALL ALLOW A MINIMUM OF SIX INCHES CLEAR TO ANY PARTITION ON THE HINGE SIE DR, UNLESS OTHERWISE INDICATED.
	ITS ARE TO MEET CLASS 'A' FIRE RATING OVER NON-COMBUSTIBLE SURFACES. PAINTS ARE TO CONFORM TO ALL ENVIRONMENTAL CODES. UIRED FIRE TREATED MATERIALS SHALL COMPLY WITH ALL GOVERNING CODES AND FIRE SPECIFICATIONS AT THE LOCAL AUTHORITARIAN LEVEL AN
BEYOND	AS OUTLINED IN THE CODE REVIEW SECTION OF THE CONSTRUCTION DOCUMENTS.
AUTHOF	ITARIAN LEVEL AND BEYOND AS OUTLINED IN THE CODE REVIEW SECTION OF THE CONSTRUCTION DOCUMENTS.
	INATED SURFACES SHALL MEET STANDARDS CLASS I, 0-25 FLAME SPREAD AND SMOKE DEVELOPED (PER ASTM AND UL TUNNEL TEST METHOD). COUSTICAL TILES TO MEET FLAME SPREAD 0-25 (ASTM E84) CLASS 'A' (FED. SPEC. SS-S118B) 25 OR UNDER (UL LABEL).
PROVID	WALL COVERINGS THAT BEAR THE UL LABEL, INDICATING THE FOLLOWING FIRE PERFORMANCE CHARACTERISTICS WHEN TESTED IN ACCORDANCE
ALL CAR	TM E84: FLAME SPREAD, CLASS 1 (A) 0-25, SMOKE DEVELOPED NOT MORE THAN 450 PET TO MEET FLAMMABILITY REQUIREMENTS OF ASTM E648 (NFPA-253 RADIANT PANEL TEST (CLASS 11, 75 OR LESS). CLASS 1, 45 WATTS PER CM2. ASS DOC-FE-I-70 PILL TEST. SMOKE DEVELOPMENT RATING SHALL BE LESS THAN 540 IN CONFORMANCE TO ASTM E84
SHALL C	MIXTURES SHALL CONFORM TO THE REQUIREMENTS OF CODES AS OUTLINED IN THE CODE REVIEW SECTION OF THE CONSTRUCTION DOCUMENTS A ONFORM TO ASTM C476. R MIXTURES SHALL CONFORM TO THE REQUIREMENTS OF CODES AS OUTLINED IN THE CODE REVIEW SECTION OF THE CONSTRUCTION DOCUMENTS
SHOP DI	ALL CONFORM TO ASTM STANDARDS. RAWINGS REQUIRED; IF NOT RECEIVED, SUBSEQUENT CONTRACTOR WILL ASSUME TOTAL RESPONSIBILITY FOR ITEMS' SIZE, PROPER FIT, MATERIALS
TEN (10)	E COMPLIANCES. WORKING DAYS ARE REQUIRED BY THE ARCHITECT FOR SHOP DRAWING REVIEW. TEN (10) WORKING DAYS ARE REQUIRED FOR ELECTRICAL, NCAL, PLUMBING, ETC., ENGINEERING REVIEW.
FIXTURE SHAFT V	ON MILLWORKER, CONTRACTOR AND OR SUBSEQUENT CONTRACTORS: ANY PENETRATIONS INTO RATED WALL SYSTEMS FOR TELEPHONE, DATA, LI S, JUNCTION BOXES, DUPLEX RECEPTACLES, FIRE ALARM SYSTEMS OR OTHER ROOM ACCESSORIES MUST HAVE A FIRE-RATED GYPSUM WALL BOARD /ALL ENCLOSURE PER ALL APPLICABLE CODES. THE RATING MUST CONTINUE AROUND AND BEHIND COMPLETE PENETRATION SO AS TO INSURE THE TY OF THE RATED ASSEMBLY.
INFORM	GS AND SECTIONS OF TRIM AND MOULDING DETAILS ARE FOR DESIGN AND LAYOUT PURPOSES BASED ON ACTUAL TRIM AND BEST AVAILABLE ATION. THEY ARE NOT INTENDED TO ACT OR TAKE PLACE OF WORKING SHOP DRAWINGS FROM A MILLWORK CONTRACTOR. ITRACTOR SHALL BE RESPONSIBLE FOR RECORD KEEPING ALL EXPOSED CONDITIONS DISCOVERED DURING THE WORK AND ALL AS-BUILT CONDITION
THE CO	NTRACTOR SHALL CHECK AND VERIFY THE EXISTING CONDITIONS AT THE SITE AGAINST THE DRAWINGS AND SPECIFICATIONS, AND INFORM THE SITE IMMEDIATELY OF ANY DISCREPANCIES PRIOR TO COMMENCEMENT OF WORK.
	ONTRACTOR FINDS CONFLICTS BETWEEN THE DRAWINGS AND THE SPECIFICATIONS OR BETWEEN TRADES THE MORE STRINGENT WILL PREVAIL.


2301BOARDWALK ATLANTIC CITY, NJ 08401 **RESTROOM RENOVATION**

THIS BUILDING IS LISTED IN THE NATIONAL REGISTER OF HISTORIC PLACES, AND ALL WORK MUST COMPLY WITH THE SECRETARY OF THE INTERIOR'S STANDARDS FOR THE TREATMENT OF HISTORIC PROPERTIES.

TERNATIONAL BUILDING CODE - NEW JERSEY EDITION Introduction TIONAL STANDARD PLUMBING CODE Introduction TIONAL ELECTRICAL CODE 90.1- TERNATIONAL MECHANICAL CODE Intrenviol TERNATIONAL FUEL GAS CODE Intrenviol TERNATIONAL FUEL GAS CODE Intrenviol TERNATIONAL FUEL GAS CODE NJAC 5 CANSI A117.1- TIONAL FIRE PROTECTION ASSOCIATION Intrenviol Selection Interviol	INTERNATIONAL BUILDING CODE - NEW JERSEY EDITION INTERNATIONAL STANDARD PLUMBING CODE NATIONAL STANDARD PLUMBING CODE NATIONAL ELECTRICAL CODE ASHRAE 90 INTERNATIONAL ELECTRICAL CODE INTERNATIONAL MECHANICAL CODE INTERNATIONAL MECHANICAL CODE INTERNATIONAL FUEL GAS CODE INTERNATIONAL FUEL GAS CODE INTERNATIONAL ENERGY CONSERVATION CODE BARRIER-FREE SUBCODE NATIONAL FIRE PROTECTION ASSOCIATION 10 11 11 11 11 11 11 11 11 11 11 11 11	CODE - NEW JERSEY EDITION 2 BING CODE 2 DE 90.1-2 AL CODE 2 CODE 2 CODE 2 DNSERVATION CODE 3 NJAC 5: A117.1-2 N ASSOCIATION 3 NED BY CHAPTER 5.23-6 "REHABILITATION SUBCODE" OF THE UNIFORM OF NEW JERSEY, QUALIFIES AS A RECONSTRUCTION. THE WORK IN TH OUTTOON OF EXTERIOR WALLS, INTERIOR WALLS, FLOORS, CELLINGS, TWORK & PLUMBING. NETTERIOR WALLS, INTERIOR WALLS, FLOORS, CELLINGS, TWORK & PLUMBING. 2 NEY	
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OOF CONSTRUCTION & SECONDARY MEMBERS 1 HR ITERIOR WALL & CEILING FINISH REQUIREMENT F - INTERNATIONAL BUILDING CODE - NEW JERSEY EDITION 2015 TA 803.3 (SPRINK) D) IT ENCLOSURES AND EXIT PASSAGEWAYS CLA OMS AND ENCLOSED SPACES			
OOF CONSTRUCTION & SECONDARY MEMBERS 1 HR ITERIOR WALL & CEILING FINISH REQUIREMENT F - INTERNATIONAL BUILDING CODE - NEW JERSEY EDITION 2015 TA 803.9 (SPRINKI D) IT ENCLOSURES AND EXIT PASSAGEWAYS CLA OMS AND ENCLOSED SPACES			
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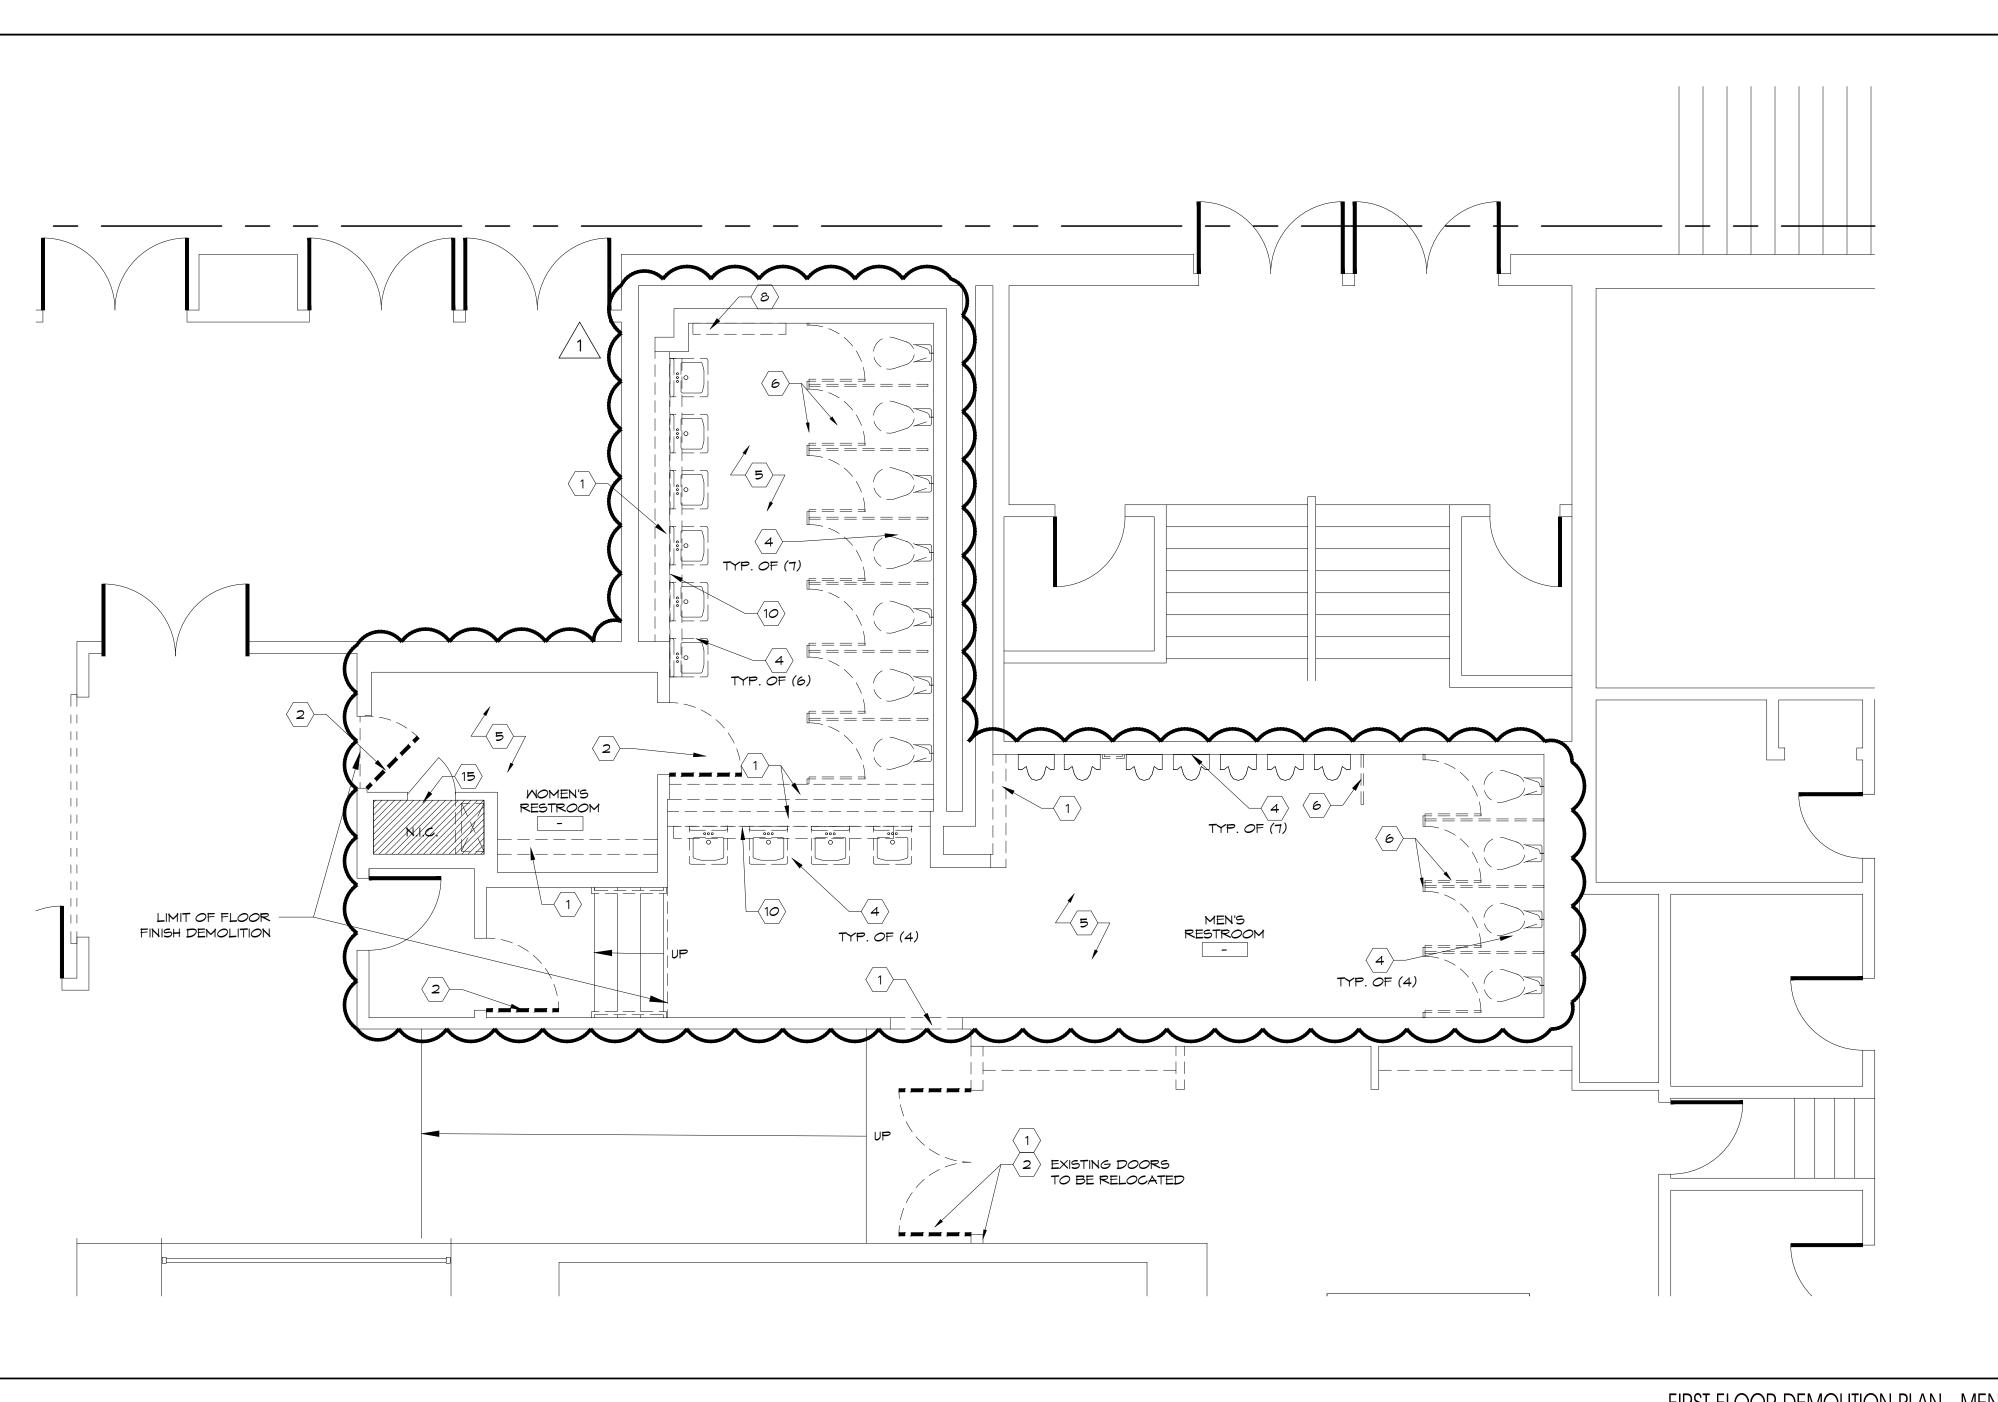
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Atlantic City, NJ 08401	
CRDA	
15 S Pennsylvania Avenue	
Atlantic City, NJ 08401	
Architect	
SOSH Architects	
1020 Atlantic Avenue	
Atlantic City, NJ 08401	
T: 609.345.5222	
Contact: Chris Menchin	
MEPFA Engineer	
Concord Atlantic Engineers	
2311 Atlantic Avenue	
Atlantic City, NJ 08401	
T: 609.246.7255	
Contact: Anthony Caucci	




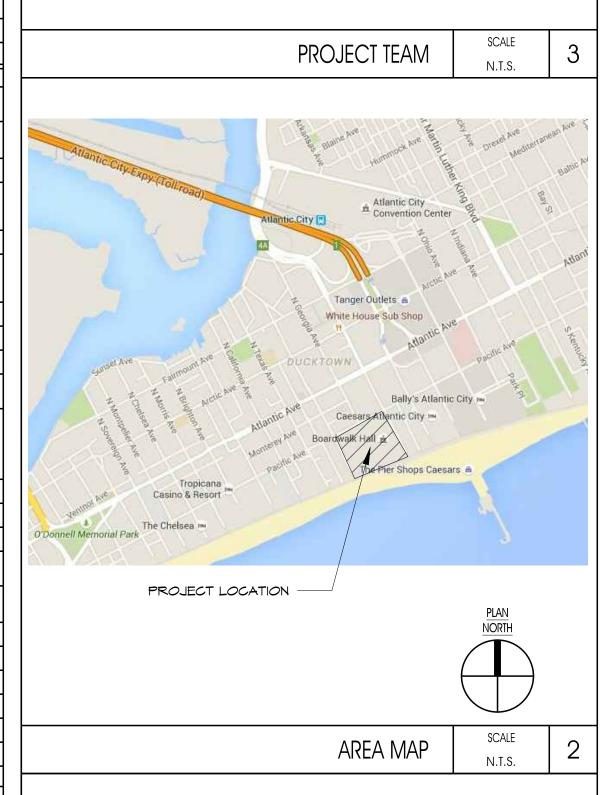
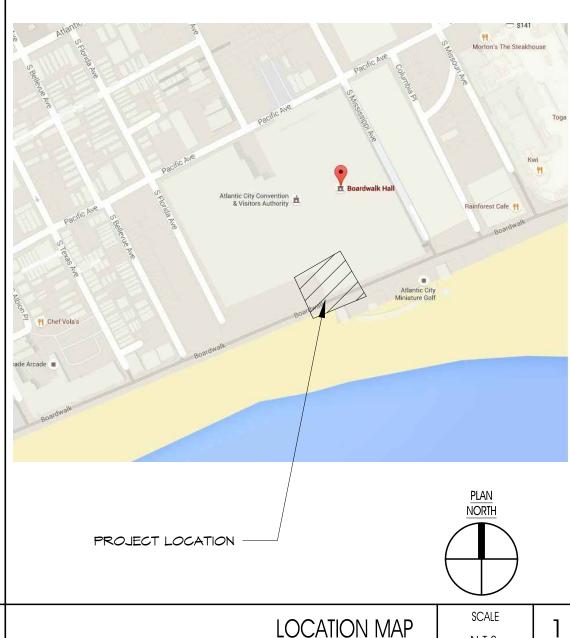
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William A. Salerno, A.I.A., P.P. Founding Principal Nory Hazaveh, A.I.A., P.P. Founding Principal Mark Petrella, A.I.A.
Principal Christopher M. Menchin, NCARB Principal Kimberly McCarron, NCARB Principal
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SUBMISSIONS
1 2016.11.30 ADDENDUM #2 10-14-2016 CONSTRUCTION DOCUMENTS
NO. I DATE: I DESCRIPTION: DRAWING TITLE:
COVER SHEET
DRAWN BY: SB DRAWING NO. REVIEWED BY: CM
PROJECT NO. 15243.00.001 AC-000

KEY	DEMOLITION NOTES LEGEND			
	DESCRIPTION REMOVE PORTION OF EXISTING WALL CONSTRUC	ΤΙΩΝ' ΡΔΤΩΗ		
01	AND REPAIR FLOOR, CEILING, AND SURROUNDIN CONSTRUCTION AS REQUIRED			
01	REMOVE EXISTING DOOR AND FRAME; PATCH AN			
02	FLOOR, CEILING, AND SURROUNDING WALL CON REQUIRED	STRUCTION AS	>	
∧ 0 <u>2A</u>	REMOVE TRANSOM PANEL ABOVE DOOR & INFIL SURROUNDING CONSTRUCTION	L TO MATCH		
1 03	NOT USED			
	REMOVE EXISTING PLUMBING FIXTURES, WATER LINES TO BE RELOCATED AS NECESSARY FOR NEV		R	
04	INSTALL; ADDITIONAL FLOOR & WALL DEMOLITIC REQUIRED			
	REMOVE EXISTING FLOOR FINISH & PREP FLOOR	FOR NEW		
	FINISH;SEE ALSO NOTE #3 REMOVE ALL EXISTING TOILET PARTITIONS & DO	ORS		
07	REMOVE ALL EXISTING RESTROOM ACCESSORIES			
08	REMOVE EXISTING RADIANT HEATERS & COVERS BELOW FLOOR & PATCH AS NEEDED	; CAP PIPING		
	REMOVE EXISTING GWB CEILING AND LIGHT FIXT REMOVE EXISTING STONE SHELVES	URES		
	REMOVE EXISTING CEILING IN ITS ENTIRETY			
12	REMOVE EXISTING CEILING FIXTURES; REFER TO INFO	MEP FOR MOR	E	
13	REMOVE EXISTING EXPOSED SPRINKLER LINES; RIPROTECTION FOR MORE INFO	EFER TO FIRE		
14	REMOVE EXISTING HEADER			
	EXISTING JANITOR CLOSET DOORS TO REMAIN; R DOOR WITH SIMILAR	\sim		
	RELOČATE EXISTING DOOR & FRAME; SEE DOOR MORE INFO		C C	
	RELOCATE EXPOSED SPRINKLER PIPE STRIP PAINT FROM EXISTING WINDOWS & PREP	FOR NEW FINI	SH	
1/			•	
	DEMOLITION NOTES EXISTING JANITORS CLOSETS TO REMAIN; DOORS	STO BF SANDE	D	
	& PAINTED; CLEAN &/OR REPAIR EXISTING DOOR	RHARDWARE	-	
	REFER TO MEP DRAWINGS FOR ADDITIONAL INFO FILL CRACKS IN EXISTING CONCRETE SLAB PRIOR		ON	
#3	OF PROPOSED FLOOR FINISHES DOOR AND FRAMES NOTED TO BE REMOVED SHA			
#4	RETURNED TO OWNER REMOVE & REPLACE ALL EXHAUST GRILLS, TYP FO			
#5	RESTROOMS; SEE MEP DRAWINGS			
	DEMOLITION LEGEND	SCALE NTS	3	



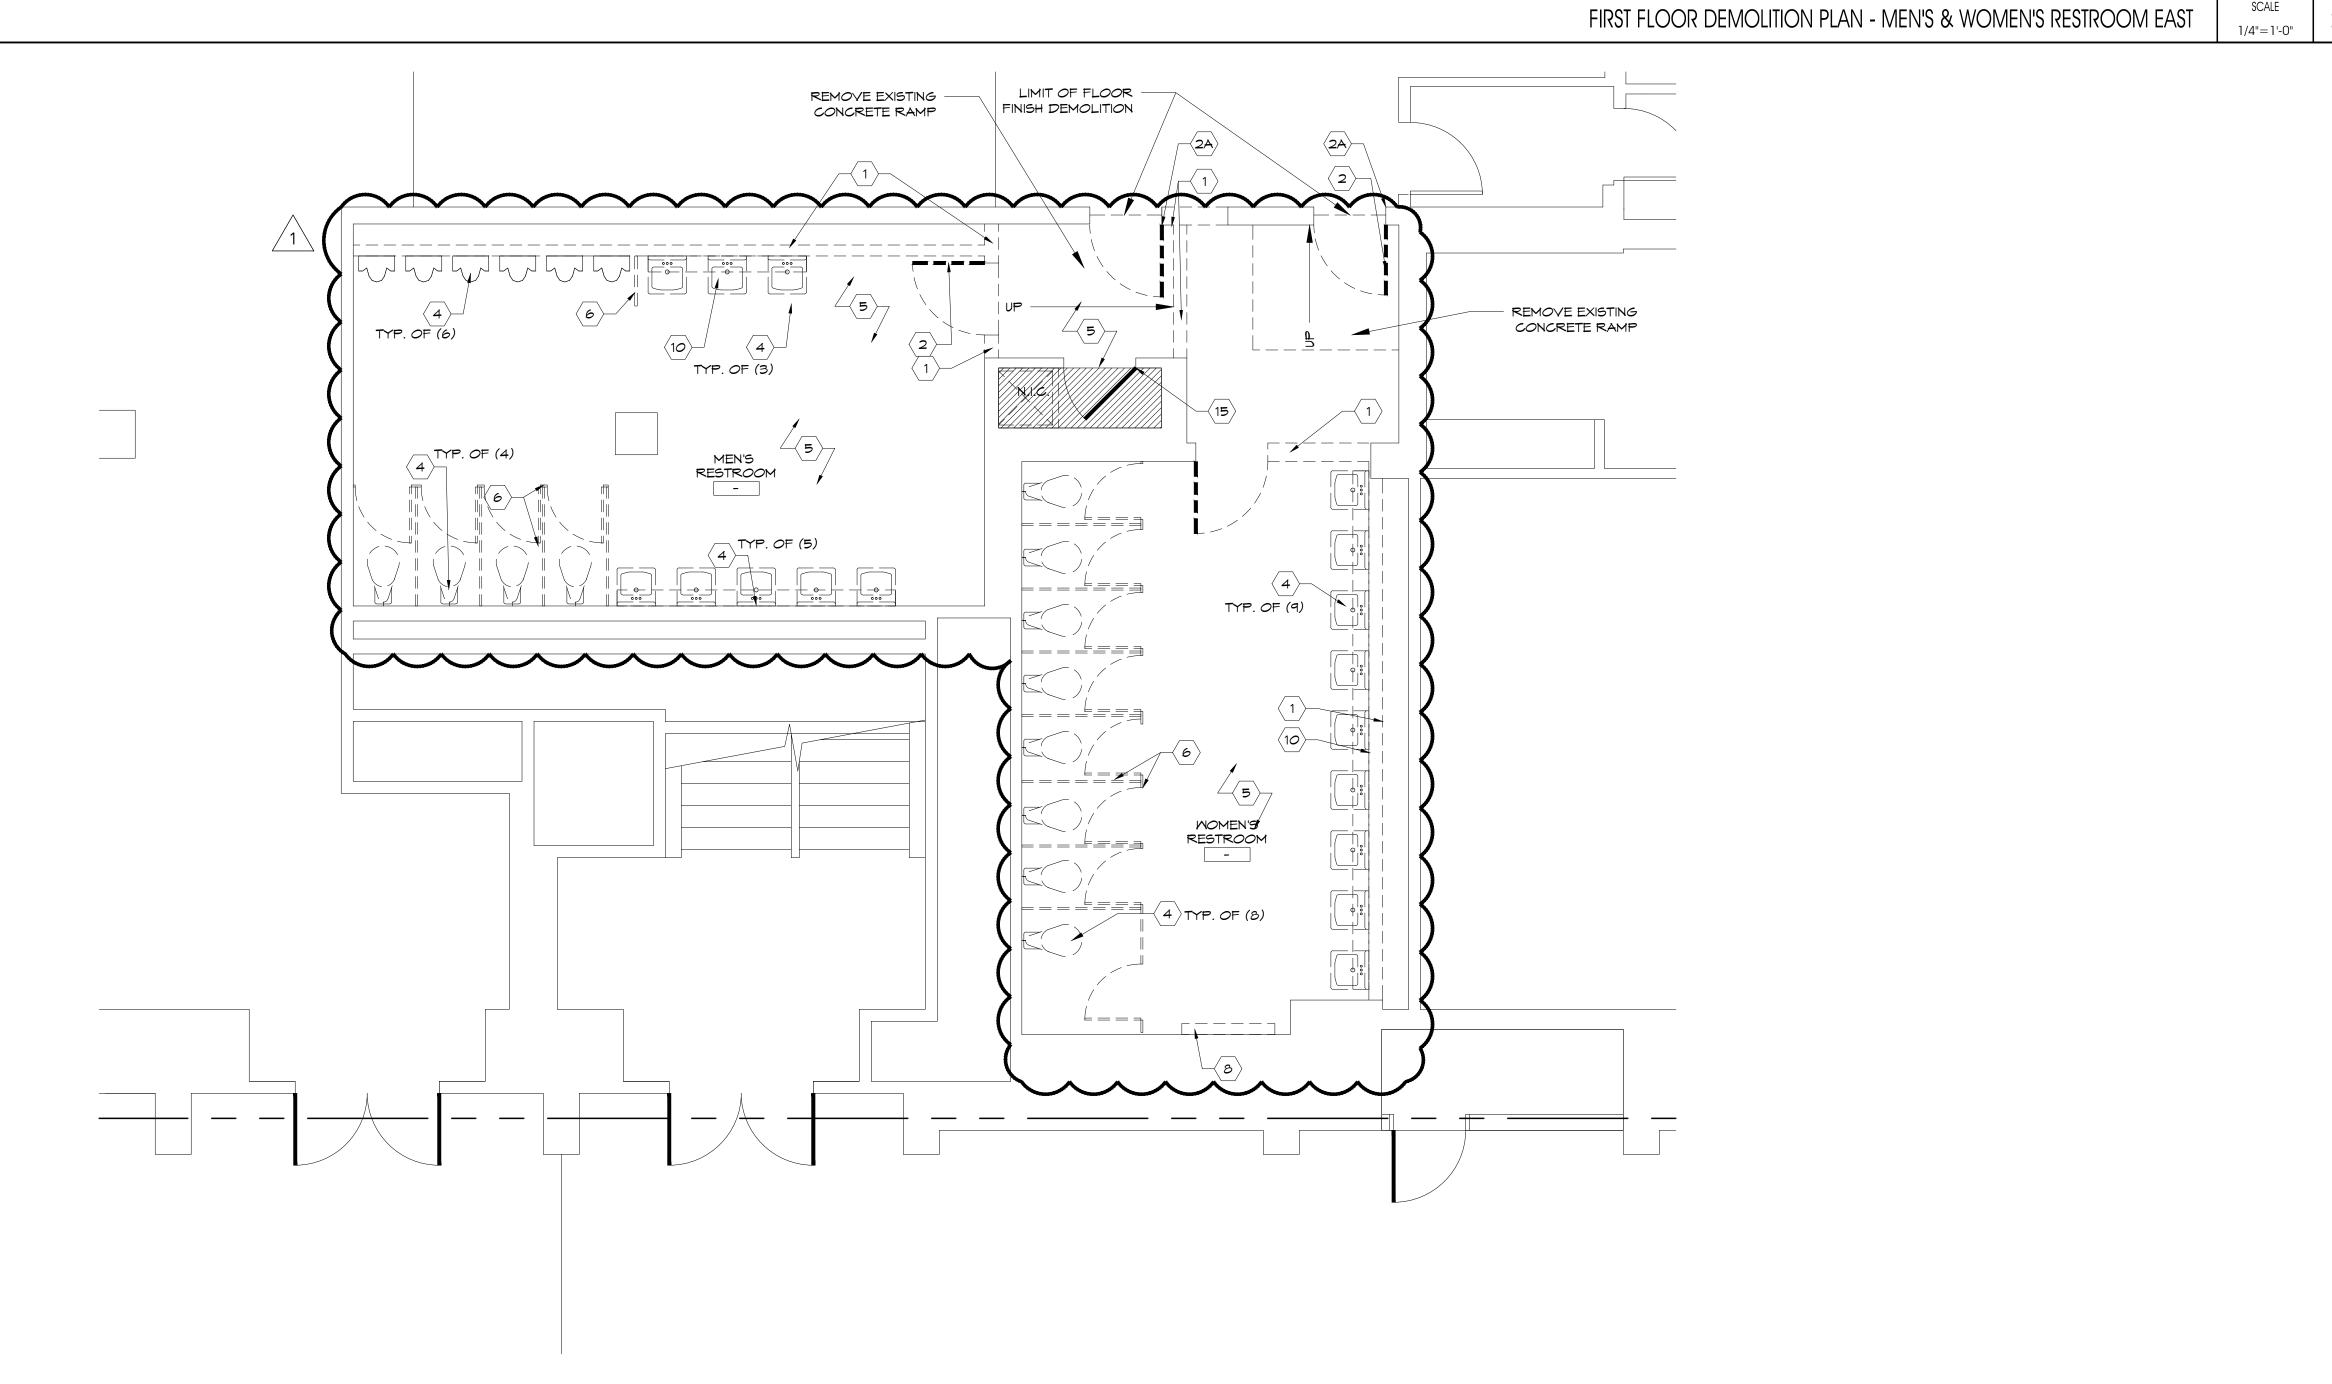


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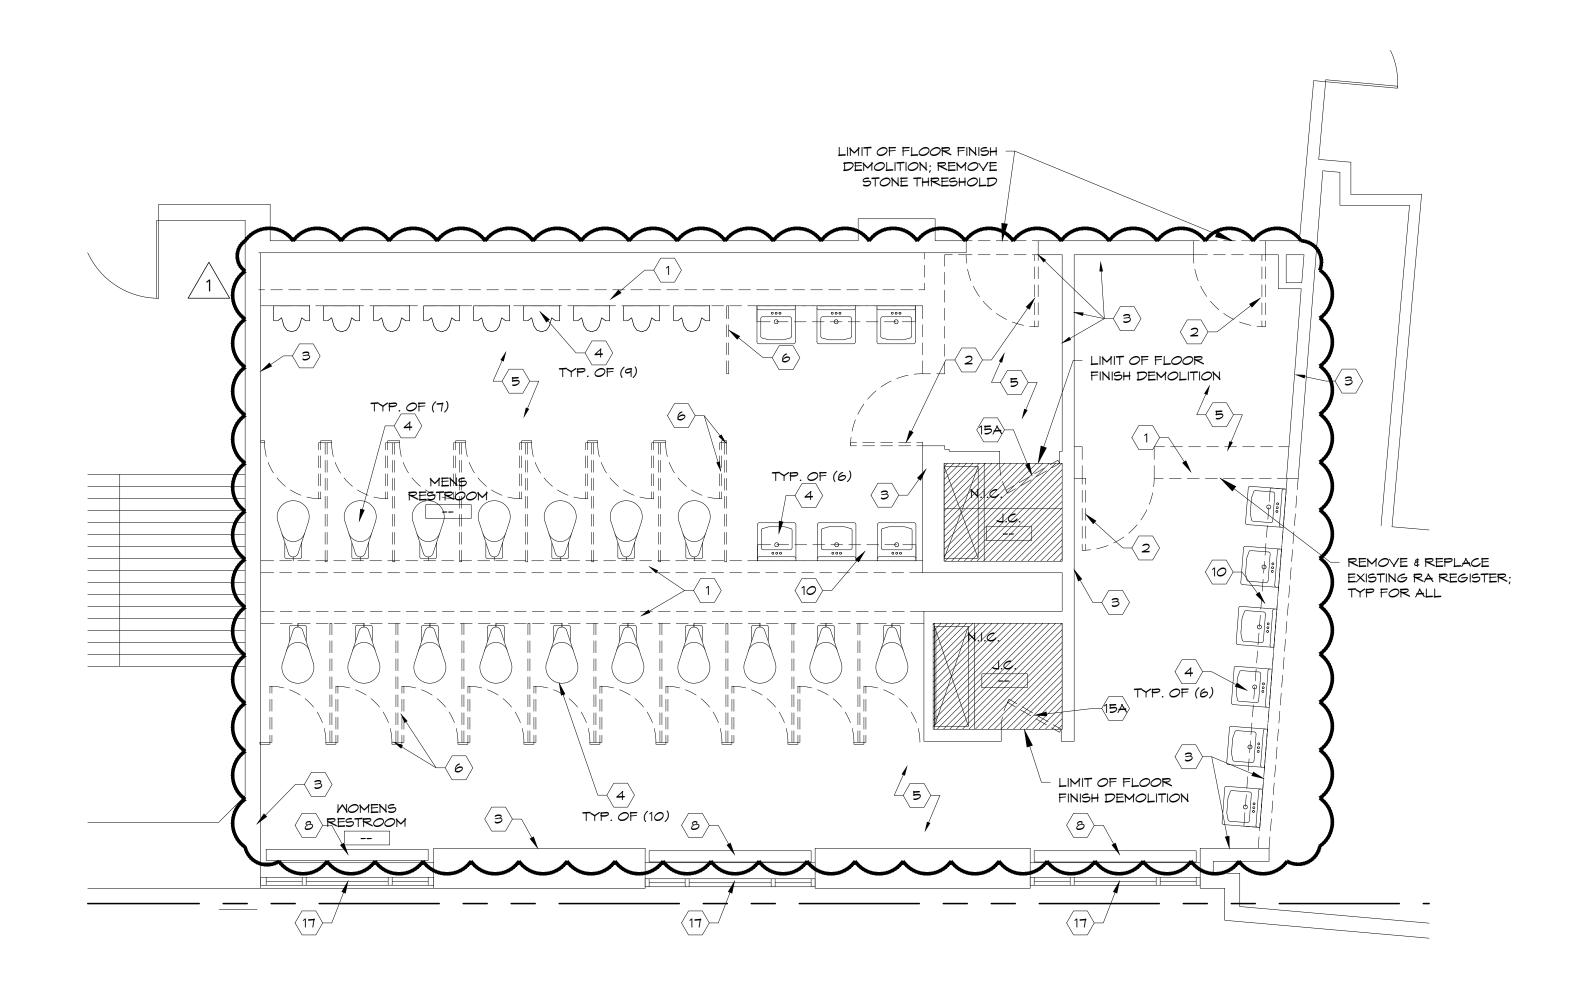
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Thomas J. Sykes, A.I.A., P.P. Founding Principal William A. Salerno, A.I.A., P.P. Founding Principal Nory Hazaveh, A.I.A., P.P. Founding Principal Mark Petrella, A.I.A. Principal Christopher M. Menchin, NCARB Principal Kimberly McCarron, NCARB Principal
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SUBMISSIONS
1 + 2016.11.30 + ADDENDUM #2 I 10-14-2016 I CONSTRUCTION DOCUMENTS
NO. I DATE: I DESCRIPTION:
DRAWING TITLE: FIRST FLOOR RESTROOM DEMOLITION PLANS
DRAWN BY: PS DRAWING NO. REVIEWED BY: CM PROJECT NO. 15243.00.001 AD-101

SCALE

	DEMOLITION NOTES LEGEND
KEY	DESCRIPTION
UNIBER	REMOVE PORTION OF EXISTING WALL CONSTRUCTION; PATCH
01	AND REPAIR FLOOR, CEILING, AND SURROUNDING WALL CONSTRUCTION AS REQUIRED
02	REMOVE EXISTING DOOR AND FRAME; PATCH AND REPAIR FLOOR, CEILING, AND SURROUNDING WALL CONSTRUCTION AS REQUIRED
	REMOVE TRANSOM PANEL ABOVE DOOR & INFILL TO MATCH SURROUNDING CONSTRUCTION
	NOT USED
	REMOVE EXISTING PLUMBING FIXTURES, WATER LINES & SEWER
04	LINES TO BE RELOCATED AS NECESSARY FOR NEW FIXTURE INSTALL; ADDITIONAL FLOOR & WALL DEMOLITION MAY BE REQUIRED
	REMOVE EXISTING FLOOR FINISH & PREP FLOOR FOR NEW
	FINISH;SEE ALSO NOTE #3 REMOVE ALL EXISTING TOILET PARTITIONS & DOORS
07	REMOVE ALL EXISTING RESTROOM ACCESSORIES REMOVE EXISTING RADIANT HEATERS & COVERS; CAP PIPING
	BELOW FLOOR & PATCH AS NEEDED REMOVE EXISTING GWB CEILING AND LIGHT FIXTURES
	REMOVE EXISTING STONE SHELVES
	REMOVE EXISTING CEILING IN ITS ENTIRETY REMOVE EXISTING CEILING FIXTURES; REFER TO MEP FOR MORE
12	INFO REMOVE EXISTING EXPOSED SPRINKLER LINES; REFER TO FIRE
	PROTECTION FOR MORE INFO REMOVE EXISTING HEADER
15	EXISTING JANITOR CLOSET DOORS TO REMAIN; REPLACE GRILL IN
	RELOCATE EXISTING DOOR & FRAME; SEE DOOR SCHEDULE FOR MORE INFO
16	RELOCATE EXPOSED SPRINKLER PIPE
17	STRIP PAINT FROM EXISTING WINDOWS & PREP FOR NEW FINISH
	DEMOLITION NOTES EXISTING JANITORS CLOSETS TO REMAIN; DOORS TO BE SANDED
#1	& PAINTED; CLEAN &/OR REPAIR EXISTING DOOR HARDWARE
	REFER TO MEP DRAWINGS FOR ADDITIONAL INFORMATION FILL CRACKS IN EXISTING CONCRETE SLAB PRIOR TO APPLICATION OF PROPOSED FLOOR FINISHES
	DOOR AND FRAMES NOTED TO BE REMOVED SHALL BE RETURNED TO OWNER
	REMOVE & REPLACE ALL EXHAUST GRILLS, TYP FOR ALL RESTROOMS; SEE MEP DRAWINGS
#5	

DEMOLITION NOTES	SCALE	2	
	N.T.S.	0	



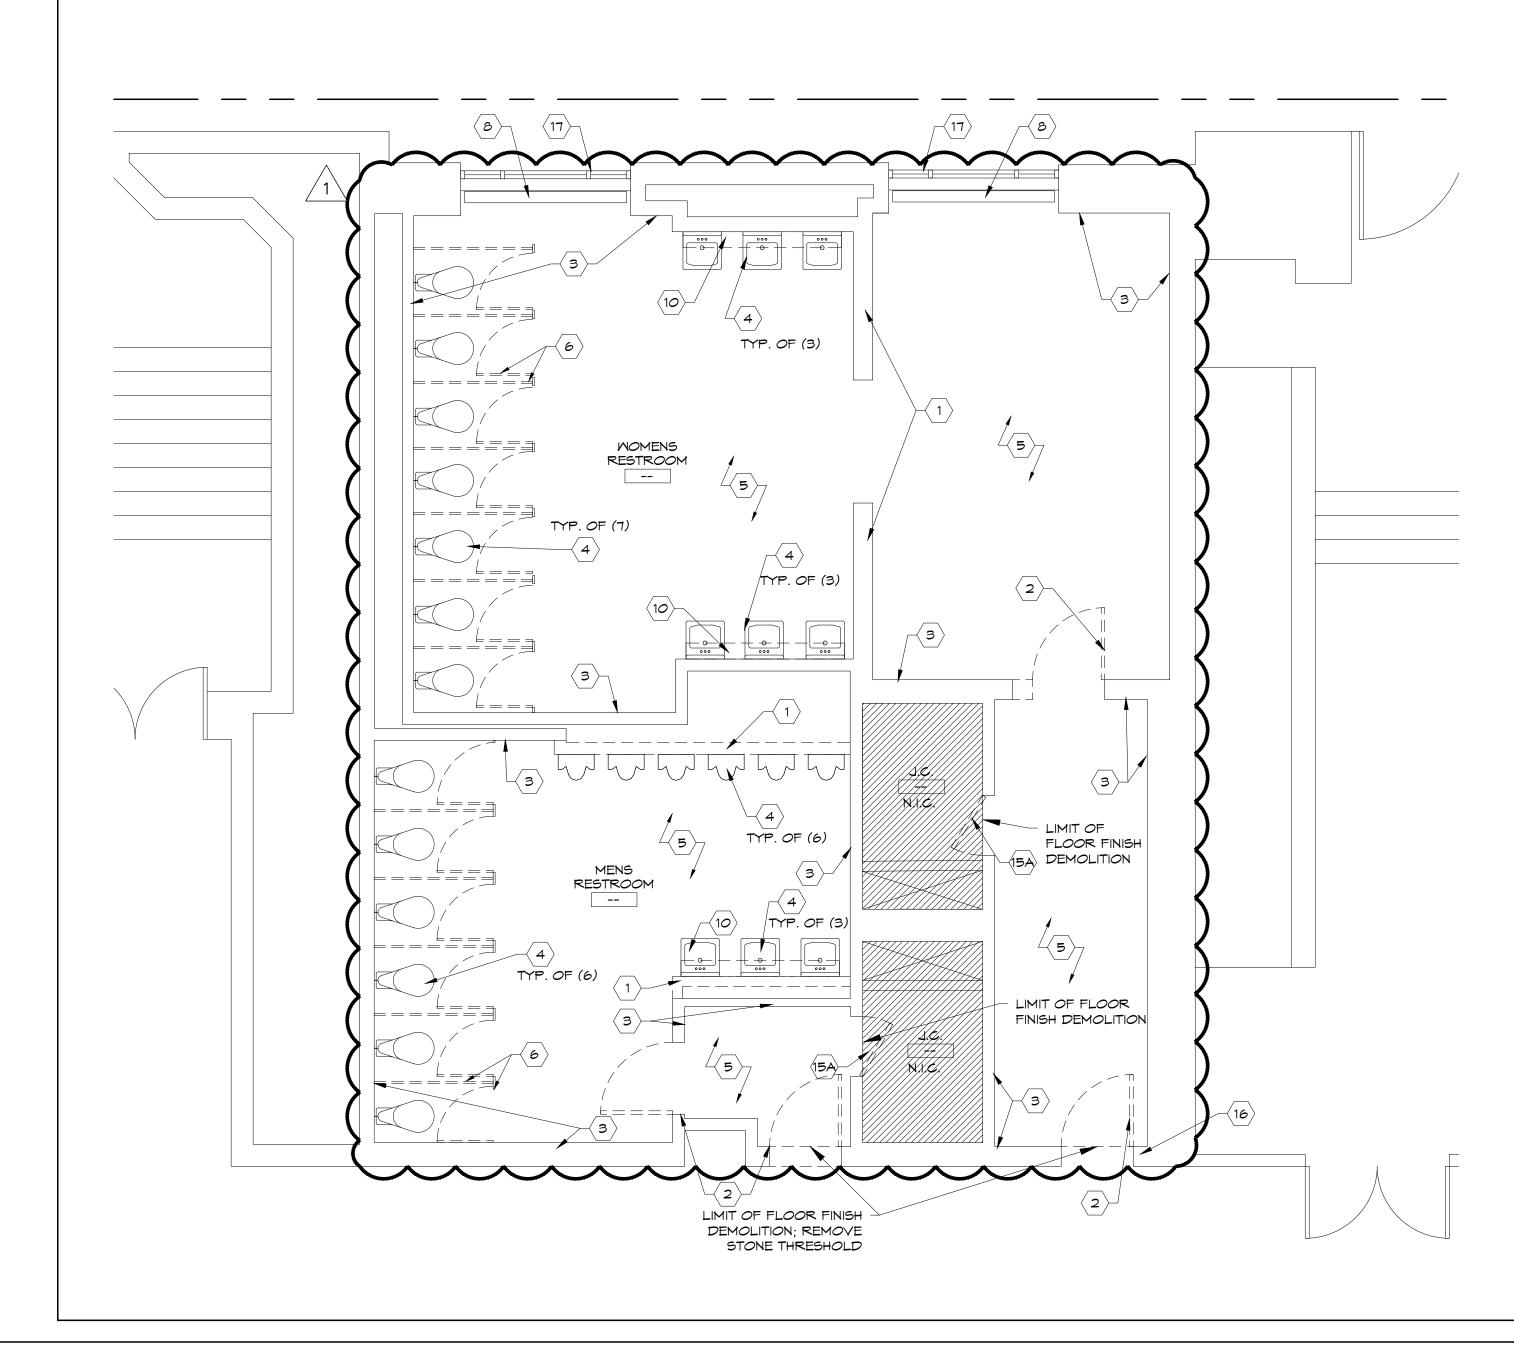



SECOND FLOOR DEMOLITION PLAN - MEN'S AND WOMEN'S RESTROOM EAST	SCALE	
SECOND FLOOR DEIVIOLITION FLAN - IVIEINS AND WOIVIEINS RESTROOIVI EAST	1/4"=1'-0"	

SCALE . 1/4"=1'-0"

SOSH
atlantic city new york 1020 Atlantic Avenue 145 West 57th Street Atlantic City, NJ 08401 New York, NY 10019 T: 609.345.5222 T: 212.246.2770 F: 609.345.7486 F: 212.246.2770
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William A. Salerno, A.I.A., P.P. Founding Principal Nory Hazaveh, A.I.A., P.P. Founding Principal Mark Petrella, A.I.A.
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 1 2016.11.30 ADDENDUM #2
I 10-14-2016 I CONSTRUCTION DOCUMENTS NO. I DATE: I DESCRIPTION:
DRAWING TITLE: SECOND FLOOR RESTROOM
DEMOLITION PLANS
DRAWN BY: PS DRAWING NO. REVIEWED BY: CM PROJECT NO. 1 5 0 4 2 00 001 ADD-102
15243.00.001

KEY	DEMOLITION NOTES LEGEND DESCRIPTION
NOWBER	REMOVE PORTION OF EXISTING WALL CONSTRUCTION; PATCH AND REPAIR FLOOR, CEILING, AND SURROUNDING WALL
01	CONSTRUCTION AS REQUIRED REMOVE EXISTING DOOR AND FRAME; PATCH AND REPAIR
02	FLOOR, CEILING, AND SURROUNDING WALL CONSTRUCTION AS REQUIRED
02A	REMOVE TRANSOM PANEL ABOVE DOOR & INFILL TO MATCH SURROUNDING CONSTRUCTION
	NOT USED
	REMOVE EXISTING PLUMBING FIXTURES, WATER LINES & SEWER LINES TO BE RELOCATED AS NECESSARY FOR NEW FIXTURE INSTALL; ADDITIONAL FLOOR & WALL DEMOLITION MAY BE
04	REQUIRED REMOVE EXISTING FLOOR FINISH & PREP FLOOR FOR NEW
	FINISH;SEE ALSO NOTE #3 REMOVE ALL EXISTING TOILET PARTITIONS & DOORS
	REMOVE ALL EXISTING RESTROOM ACCESSORIES
	REMOVE EXISTING RADIANT HEATERS & COVERS; CAP PIPING BELOW FLOOR & PATCH AS NEEDED
	REMOVE EXISTING GWB CEILING AND LIGHT FIXTURES REMOVE EXISTING STONE SHELVES
	REMOVE EXISTING CEILING IN ITS ENTIRETY REMOVE EXISTING CEILING FIXTURES; REFER TO MEP FOR MORE
	INFO REMOVE EXISTING EXPOSED SPRINKLER LINES; REFER TO FIRE PROTECTION FOR MORE INFO
	REMOVE EXISTING HEADER
	EXISTING JANITOR CLOSET DOORS TO REMAIN; REPLACE GRILL IN DOOR WITH SIMILAR
	RELOČATE EXISTING DOOR & FRAME; SEĚ DOOR SCHEĎULE FÖR MORE INFO
	RELOCATE EXPOSED SPRINKLER PIPE STRIP PAINT FROM EXISTING WINDOWS & PREP FOR NEW FINISH
	DEMOLITION NOTES
#1	EXISTING JANITORS CLOSETS TO REMAIN; DOORS TO BE SANDED & PAINTED; CLEAN &/OR REPAIR EXISTING DOOR HARDWARE
#2	REFER TO MEP DRAWINGS FOR ADDITIONAL INFORMATION FILL CRACKS IN EXISTING CONCRETE SLAB PRIOR TO APPLICATION
	OF PROPOSED FLOOR FINISHES DOOR AND FRAMES NOTED TO BE REMOVED SHALL BE
	RETURNED TO OWNER REMOVE & REPLACE ALL EXHAUST GRILLS, TYP FOR ALL
#5	RESTROOMS; SEE MEP DRAWINGS
	SCALE SCALE
	DEMOLITION LEGEND SCALE 3

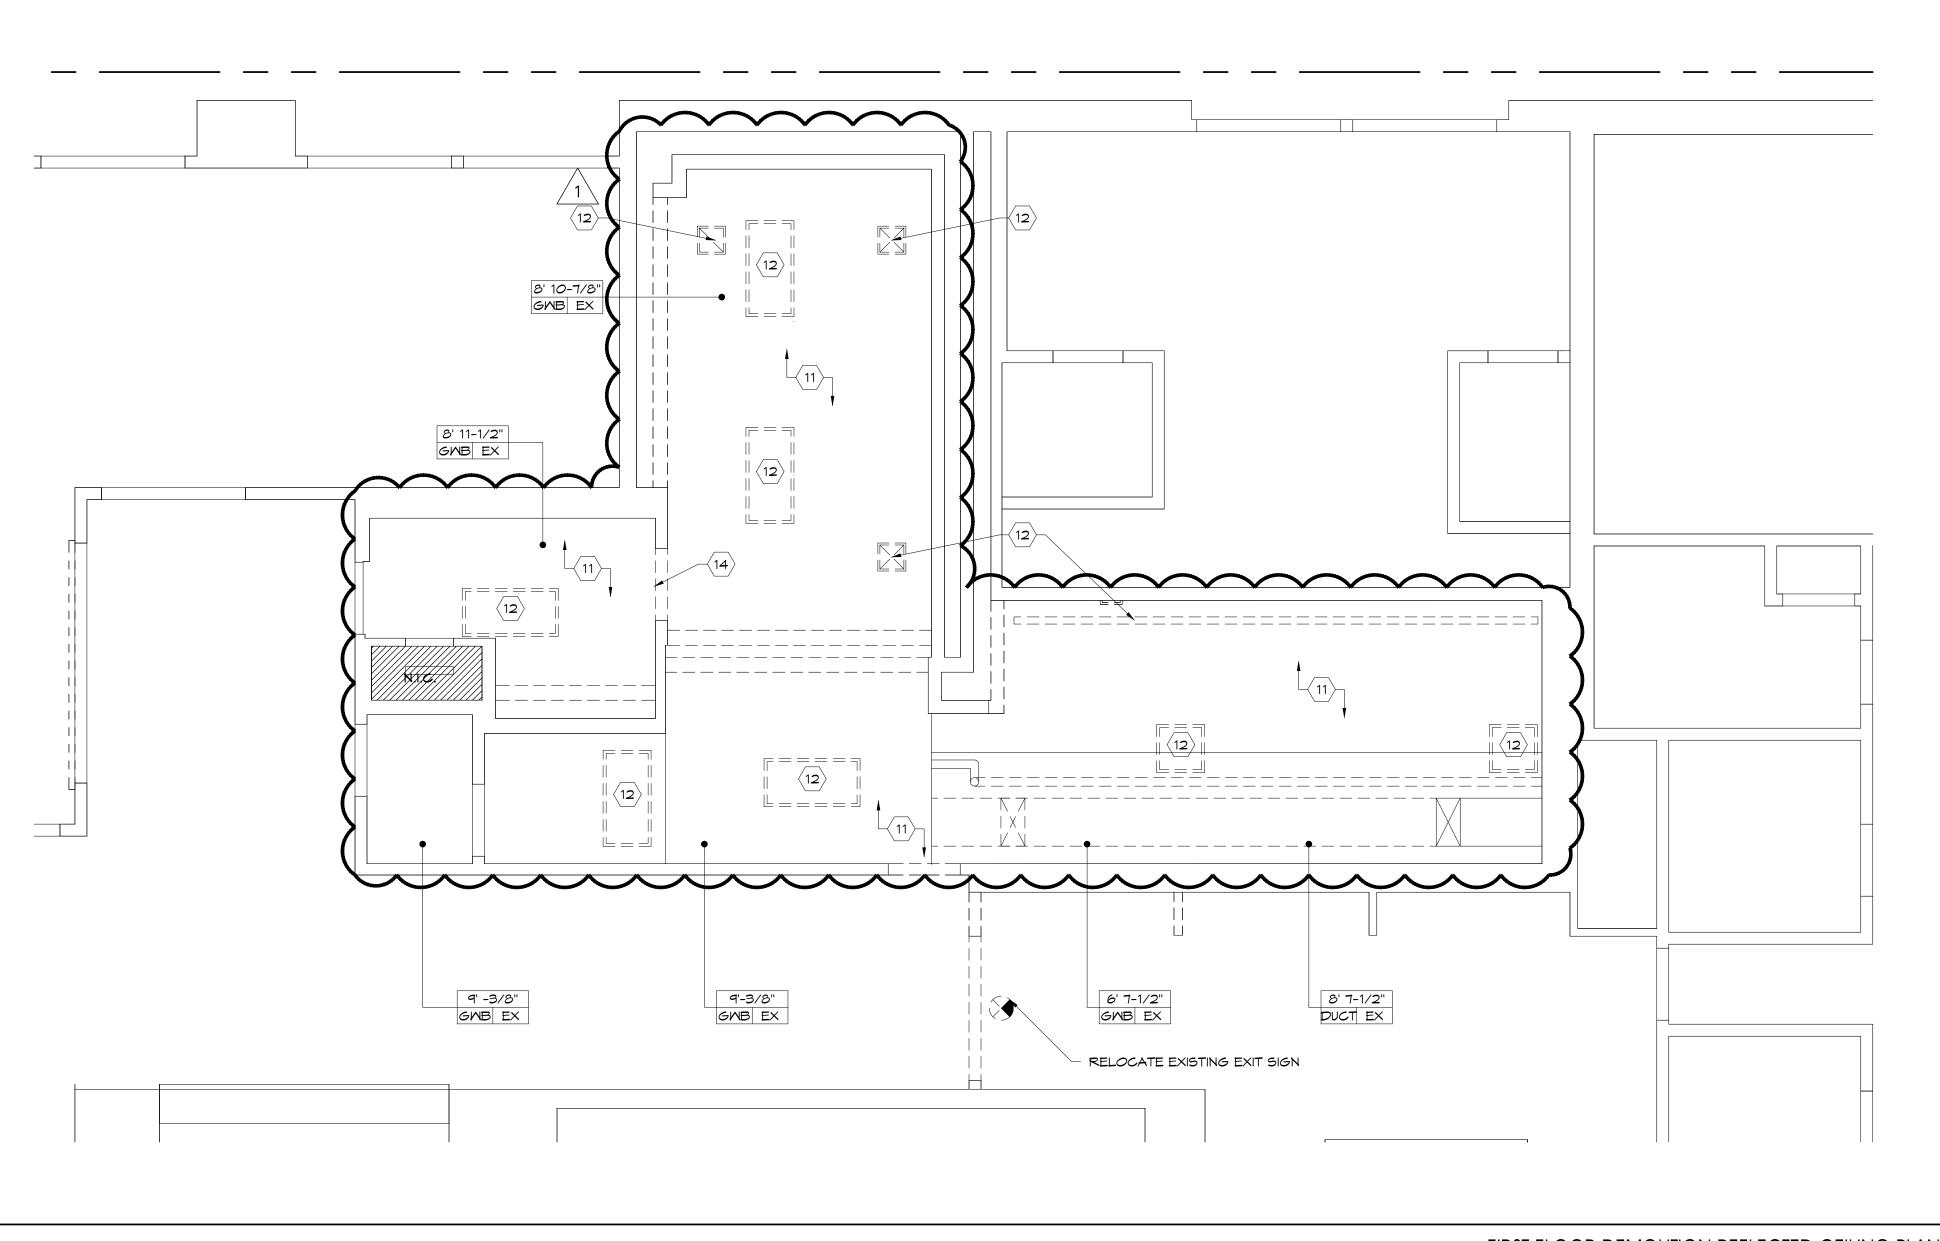

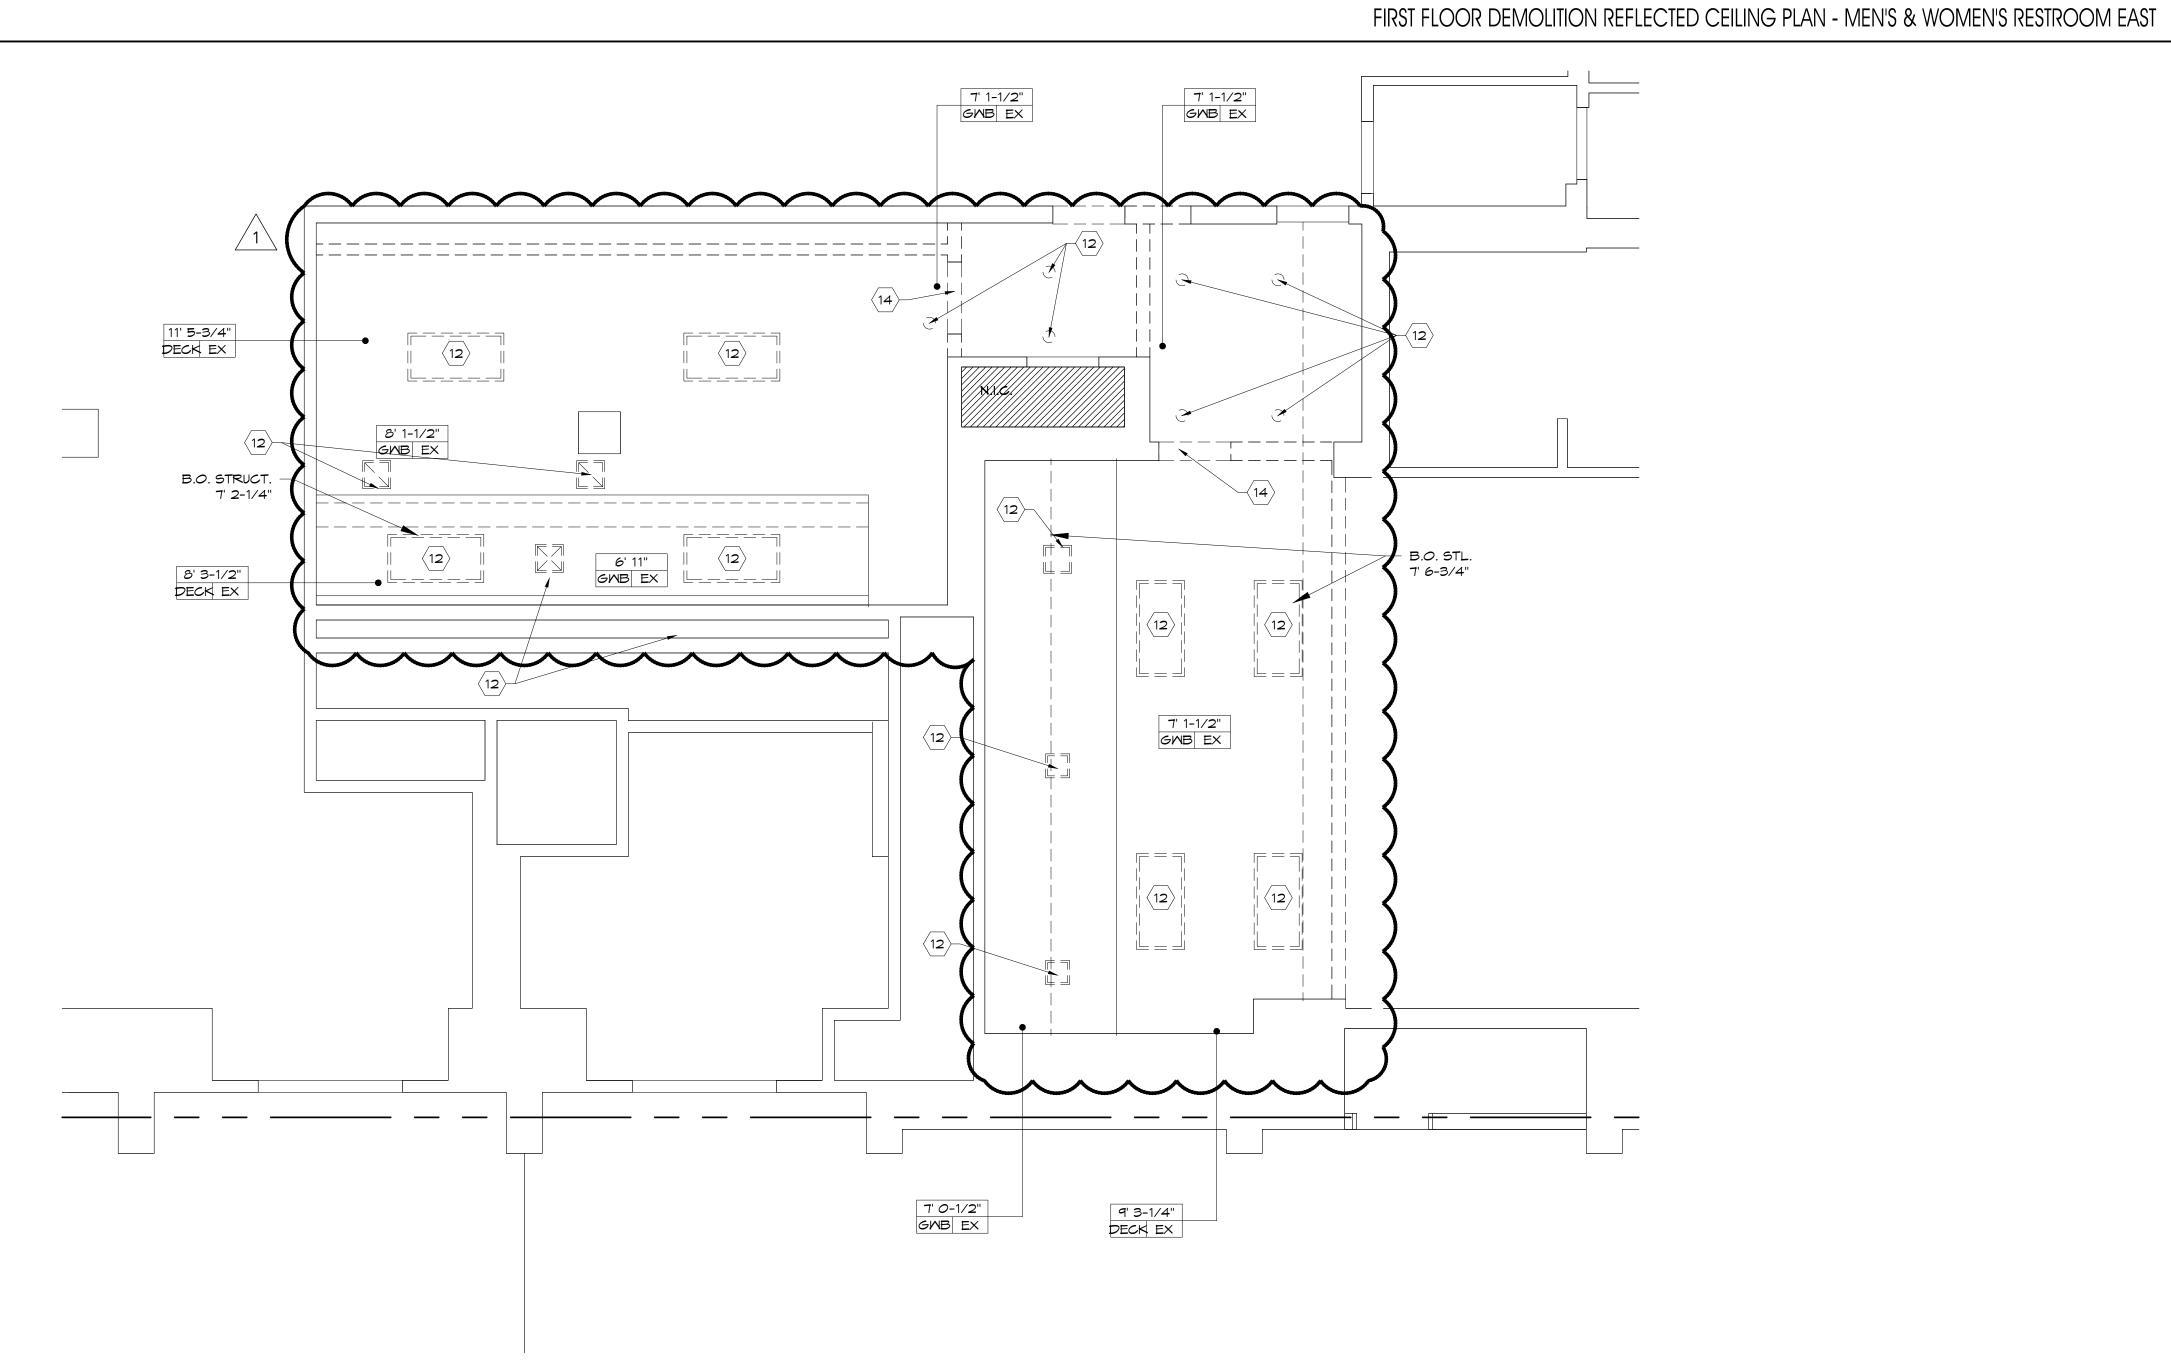


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Atlantic City, NJ 08401 New York, NY 10019 T: 609.345.5222 T: 212.246.2770 F: 609.345.7486 F: 212.246.2770 www.sosharch.com Thomas J. Sykes, A.I.A., P.P. Founding Principal William A. Salerno, A.I.A., P.P. Founding Principal Nory Hazaveh, A.I.A., P.P. Founding Principal Mark Petrella, A.I.A. Principal Christopher M. Menchin, NCARB Principal Kimberly McCarron, NCARB Principal
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I I I I
DRAWING TITLE: FIRST FLOOR RESTROOM DEMOLITION REFLECTED CEILING PLANS
DRAWN BY: PS DRAWING NO. REVIEWED BY: CM PROJECT NO. 15243.00.001 AD-201


SCALE

1/4"=1'-0"

	DEMOLITION NOTES LEGEND
KEY	DESCRIPTION
UNIBER	REMOVE PORTION OF EXISTING WALL CONSTRUCTION; PATCH
01	AND REPAIR FLOOR, CEILING, AND SURROUNDING WALL CONSTRUCTION AS REQUIRED
02	REMOVE EXISTING DOOR AND FRAME; PATCH AND REPAIR FLOOR, CEILING, AND SURROUNDING WALL CONSTRUCTION AS REQUIRED
	REMOVE TRANSOM PANEL ABOVE DOOR & INFILL TO MATCH SURROUNDING CONSTRUCTION
	NOT USED
	REMOVE EXISTING PLUMBING FIXTURES, WATER LINES & SEWER
04	LINES TO BE RELOCATED AS NECESSARY FOR NEW FIXTURE INSTALL; ADDITIONAL FLOOR & WALL DEMOLITION MAY BE REQUIRED
	REMOVE EXISTING FLOOR FINISH & PREP FLOOR FOR NEW
	FINISH;SEE ALSO NOTE #3 REMOVE ALL EXISTING TOILET PARTITIONS & DOORS
07	REMOVE ALL EXISTING RESTROOM ACCESSORIES REMOVE EXISTING RADIANT HEATERS & COVERS; CAP PIPING
	BELOW FLOOR & PATCH AS NEEDED REMOVE EXISTING GWB CEILING AND LIGHT FIXTURES
	REMOVE EXISTING STONE SHELVES
	REMOVE EXISTING CEILING IN ITS ENTIRETY REMOVE EXISTING CEILING FIXTURES; REFER TO MEP FOR MORE
12	INFO REMOVE EXISTING EXPOSED SPRINKLER LINES; REFER TO FIRE
	PROTECTION FOR MORE INFO REMOVE EXISTING HEADER
15	EXISTING JANITOR CLOSET DOORS TO REMAIN; REPLACE GRILL IN
	RELOCATE EXISTING DOOR & FRAME; SEE DOOR SCHEDULE FOR MORE INFO
16	RELOCATE EXPOSED SPRINKLER PIPE
17	STRIP PAINT FROM EXISTING WINDOWS & PREP FOR NEW FINISH
	DEMOLITION NOTES EXISTING JANITORS CLOSETS TO REMAIN; DOORS TO BE SANDED
#1	& PAINTED; CLEAN &/OR REPAIR EXISTING DOOR HARDWARE
	REFER TO MEP DRAWINGS FOR ADDITIONAL INFORMATION FILL CRACKS IN EXISTING CONCRETE SLAB PRIOR TO APPLICATION OF PROPOSED FLOOR FINISHES
	DOOR AND FRAMES NOTED TO BE REMOVED SHALL BE RETURNED TO OWNER
	REMOVE & REPLACE ALL EXHAUST GRILLS, TYP FOR ALL RESTROOMS; SEE MEP DRAWINGS
#5	


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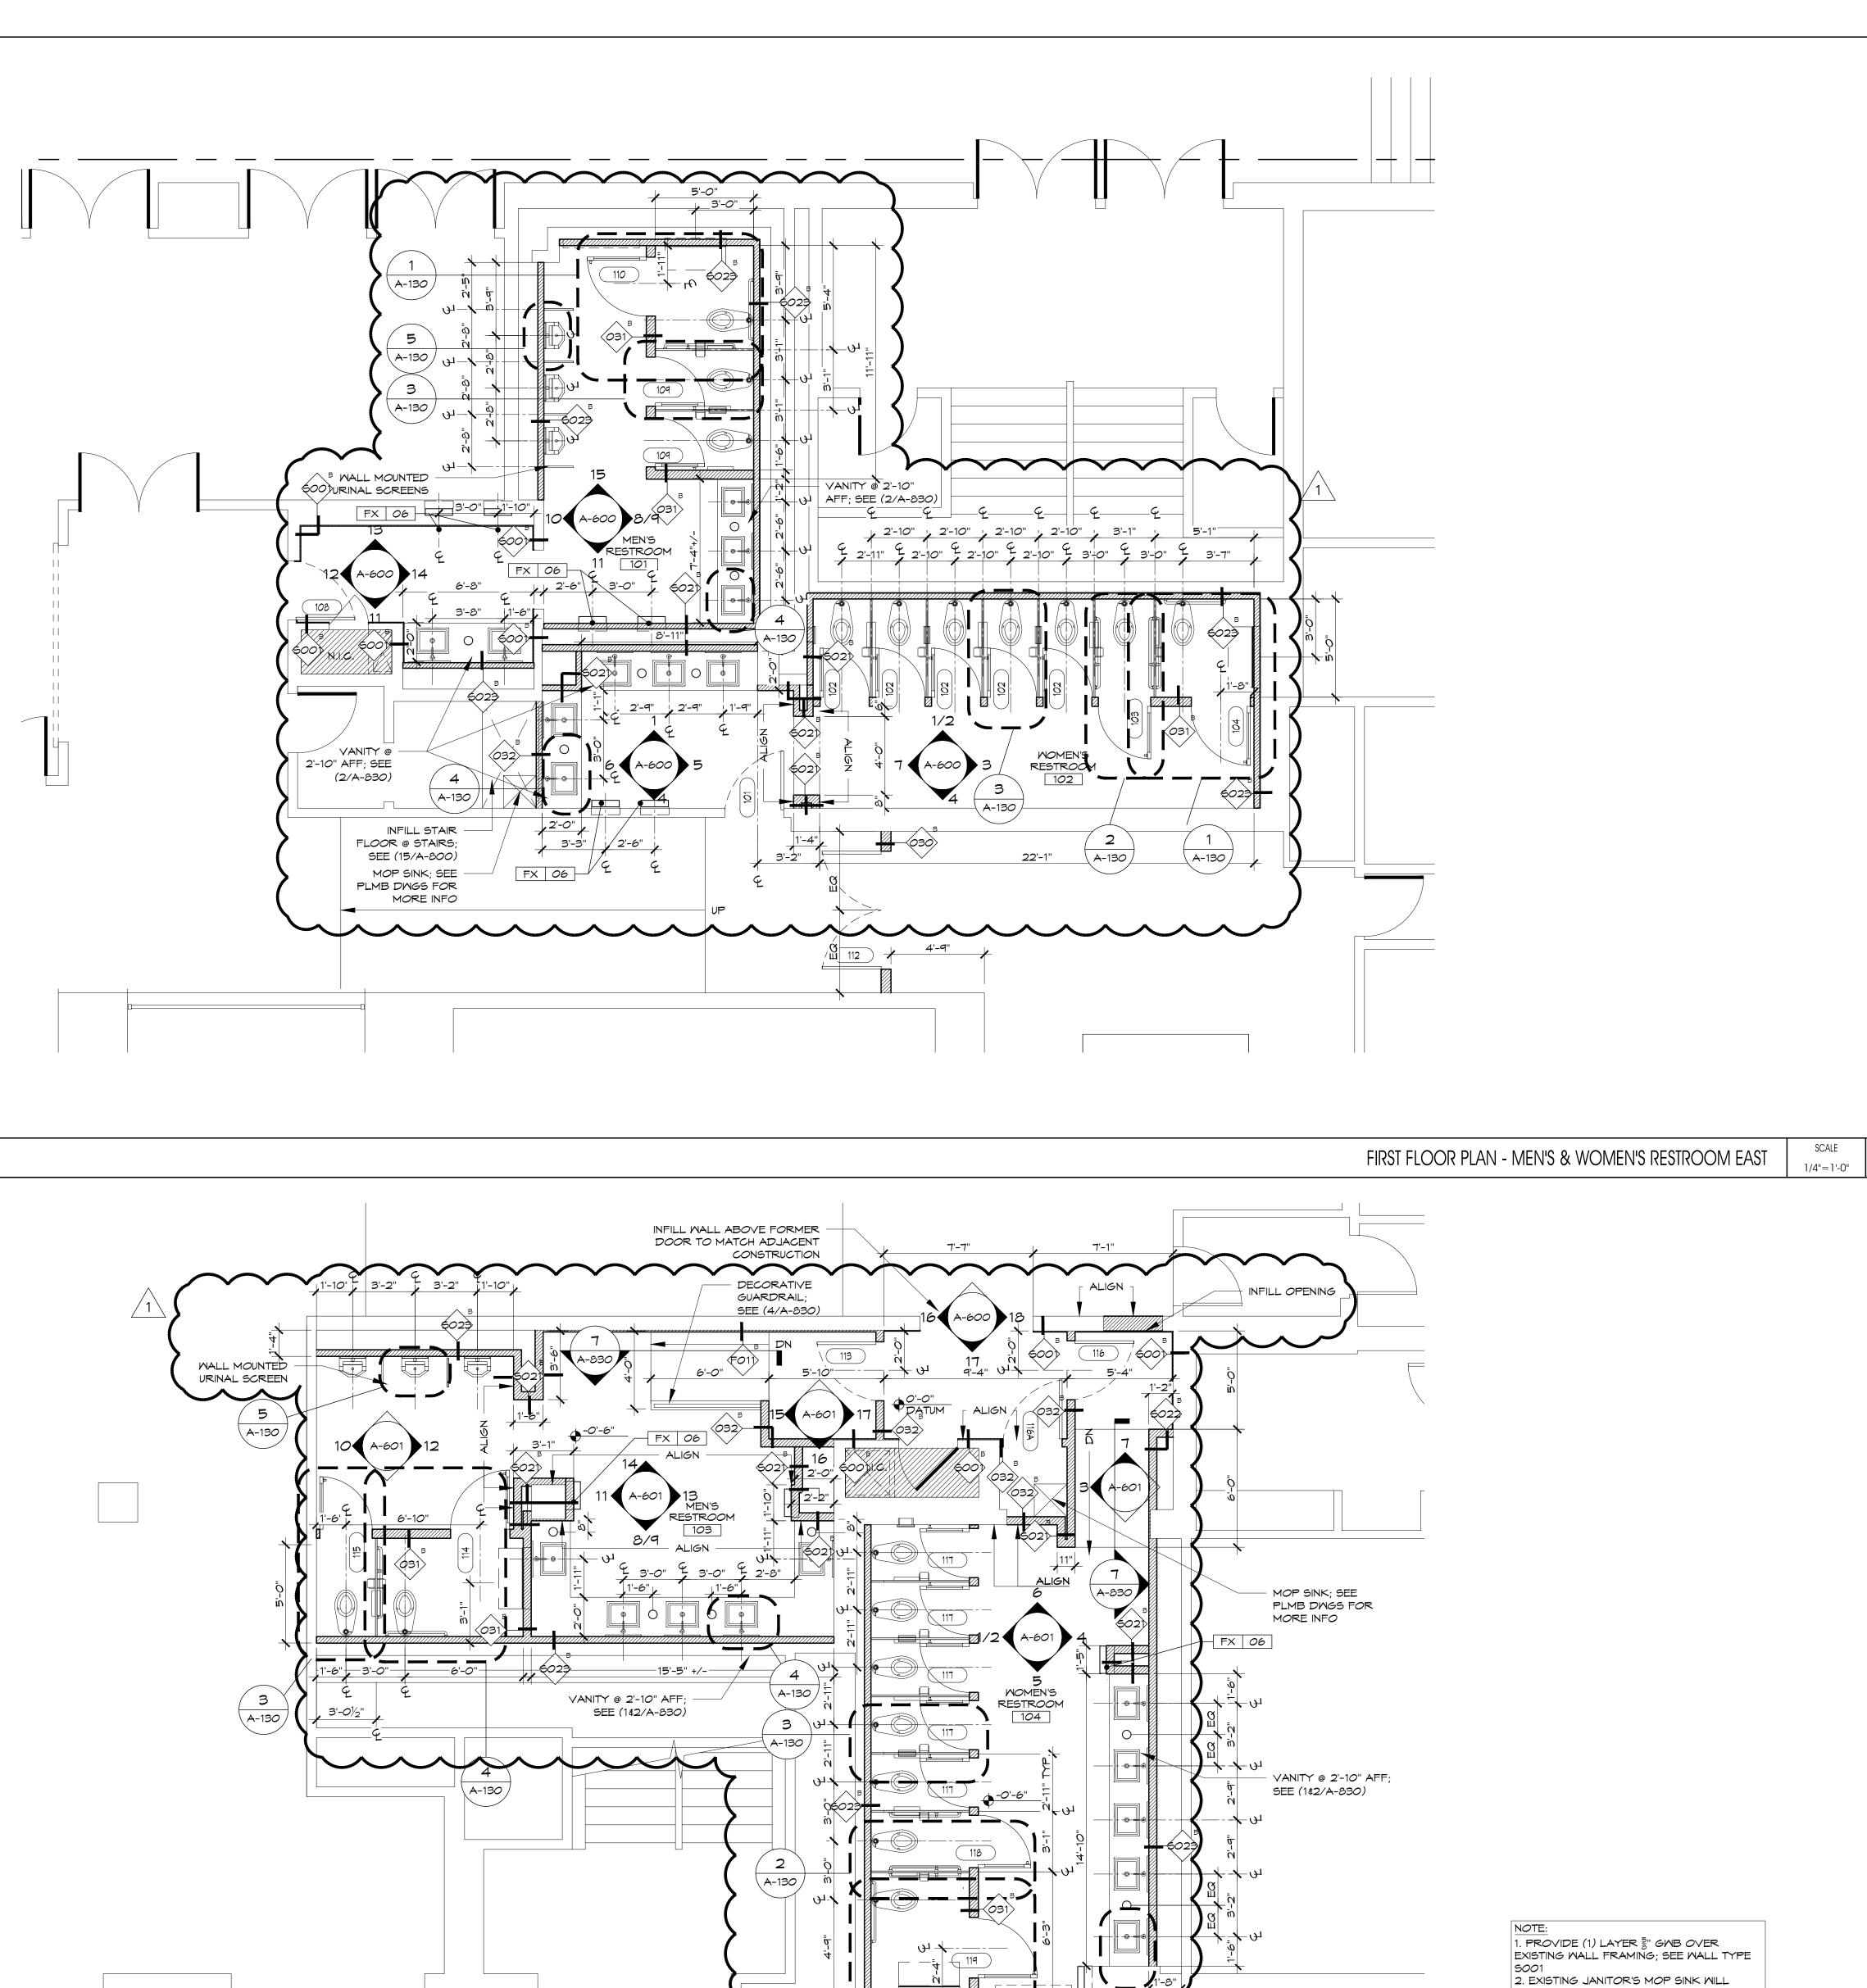


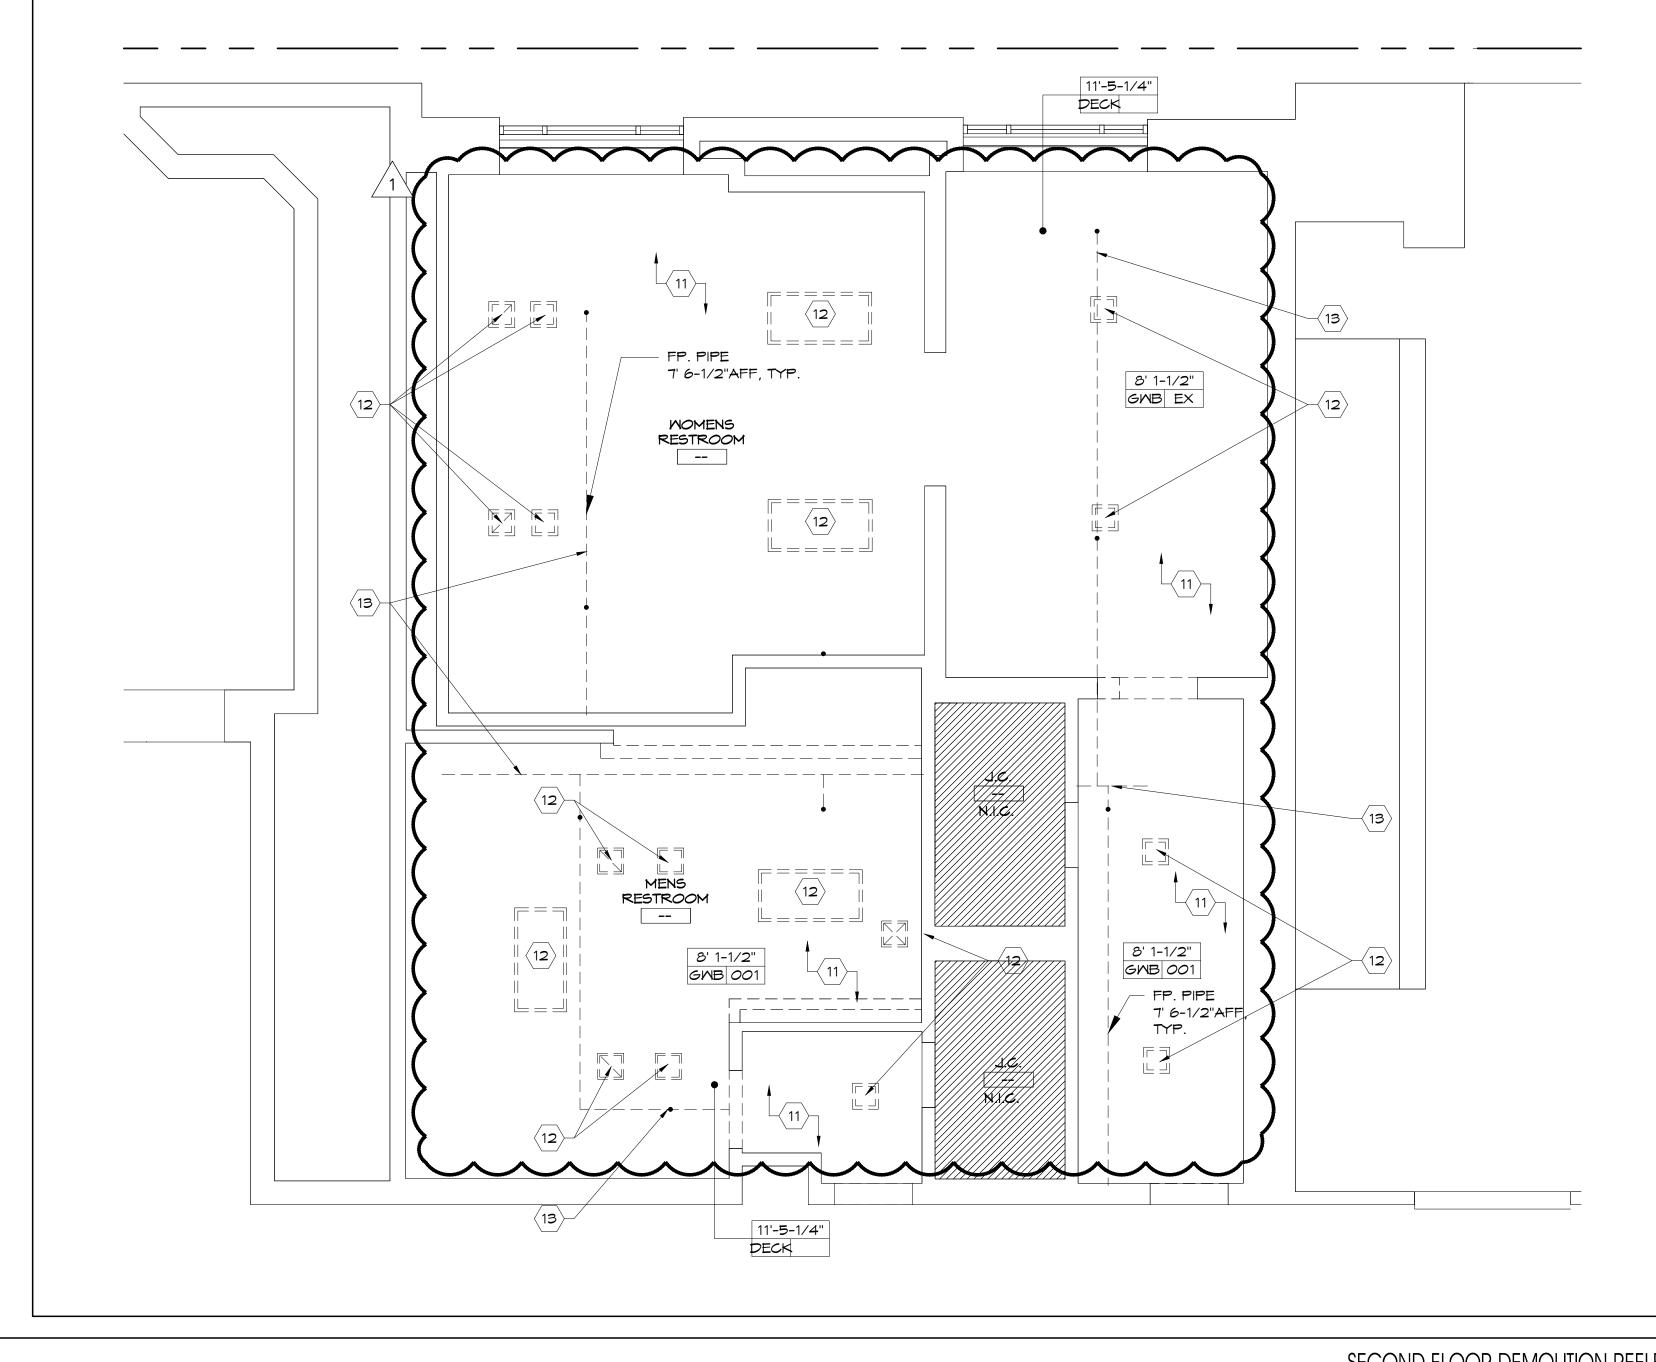


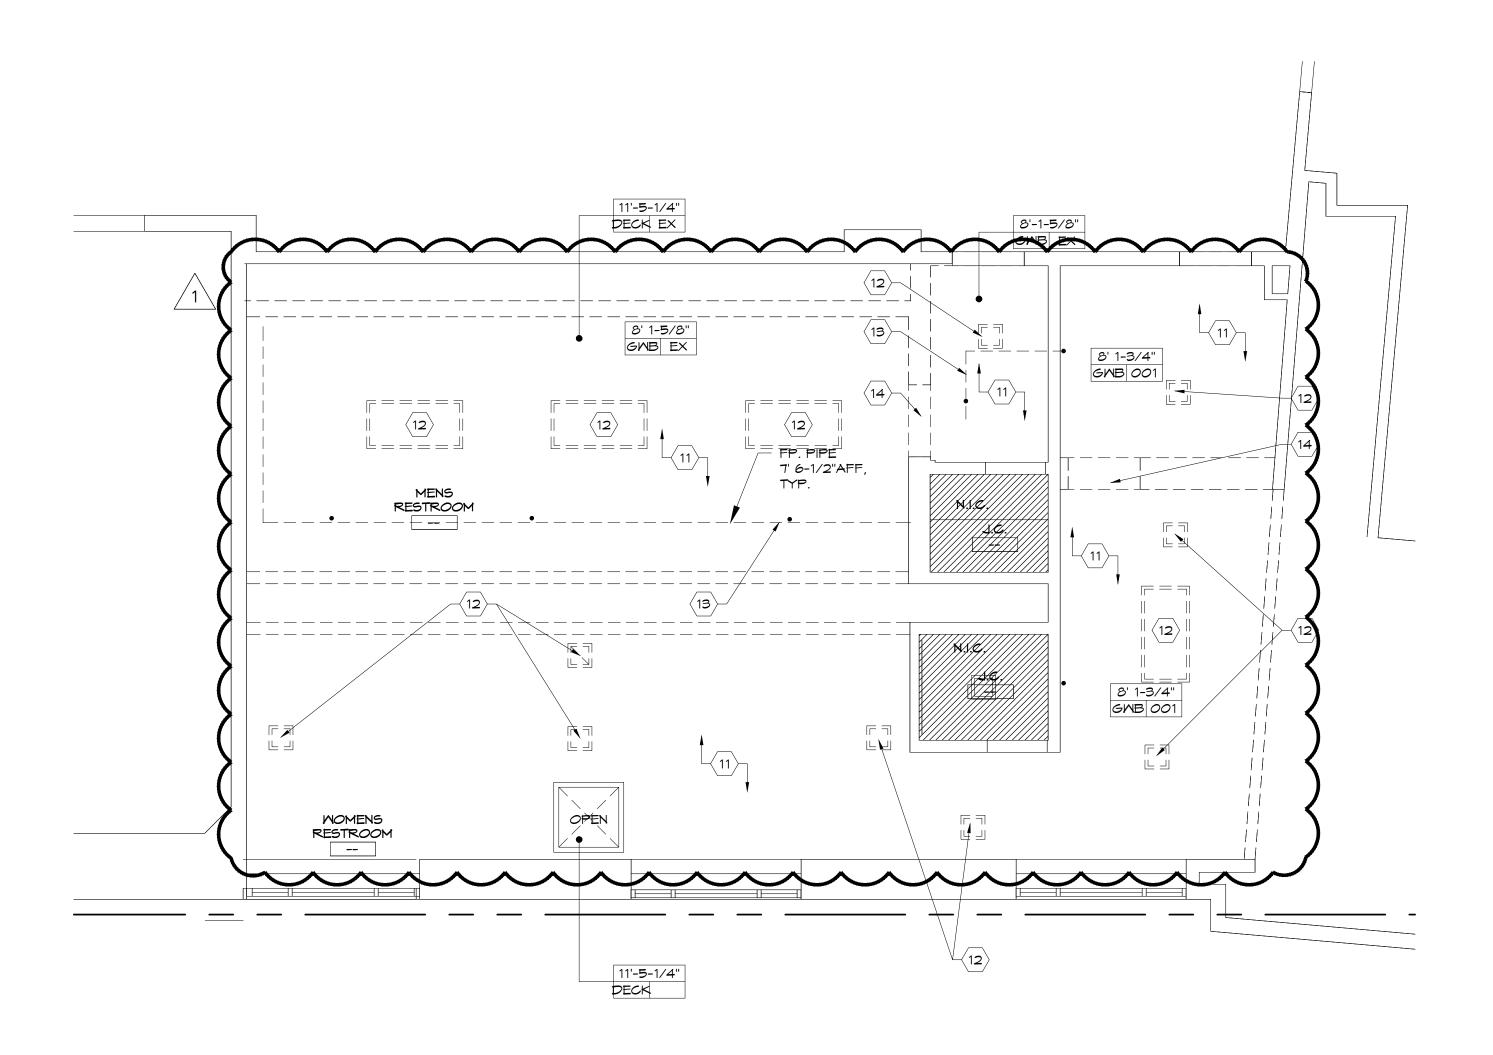SCALE SECOND FLOOR DEMOLITION REFLECTED CEILING PLAN - MEN'S AND WOMEN'S RESTROOM EAST 1/4"=1'-0"


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SECOND FLOOR RESTROOM DEMOLITION REFLECTED CEILING PLAN
DRAWN BY: PS DRAWING NO. REVIEWED BY: CM PROJECT NO. 15243.00.001 ADJ-202




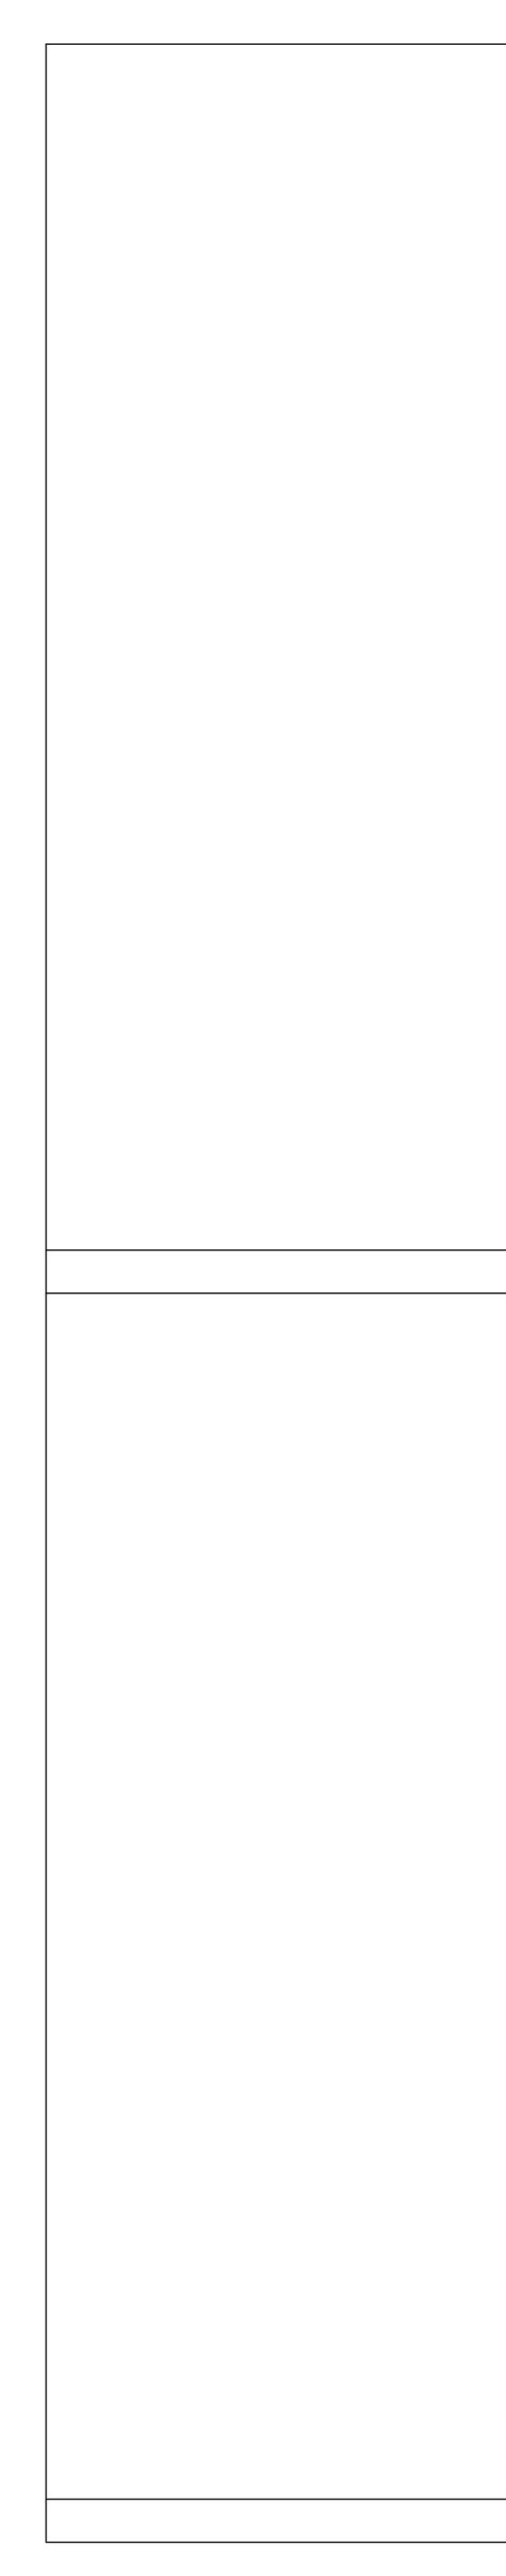


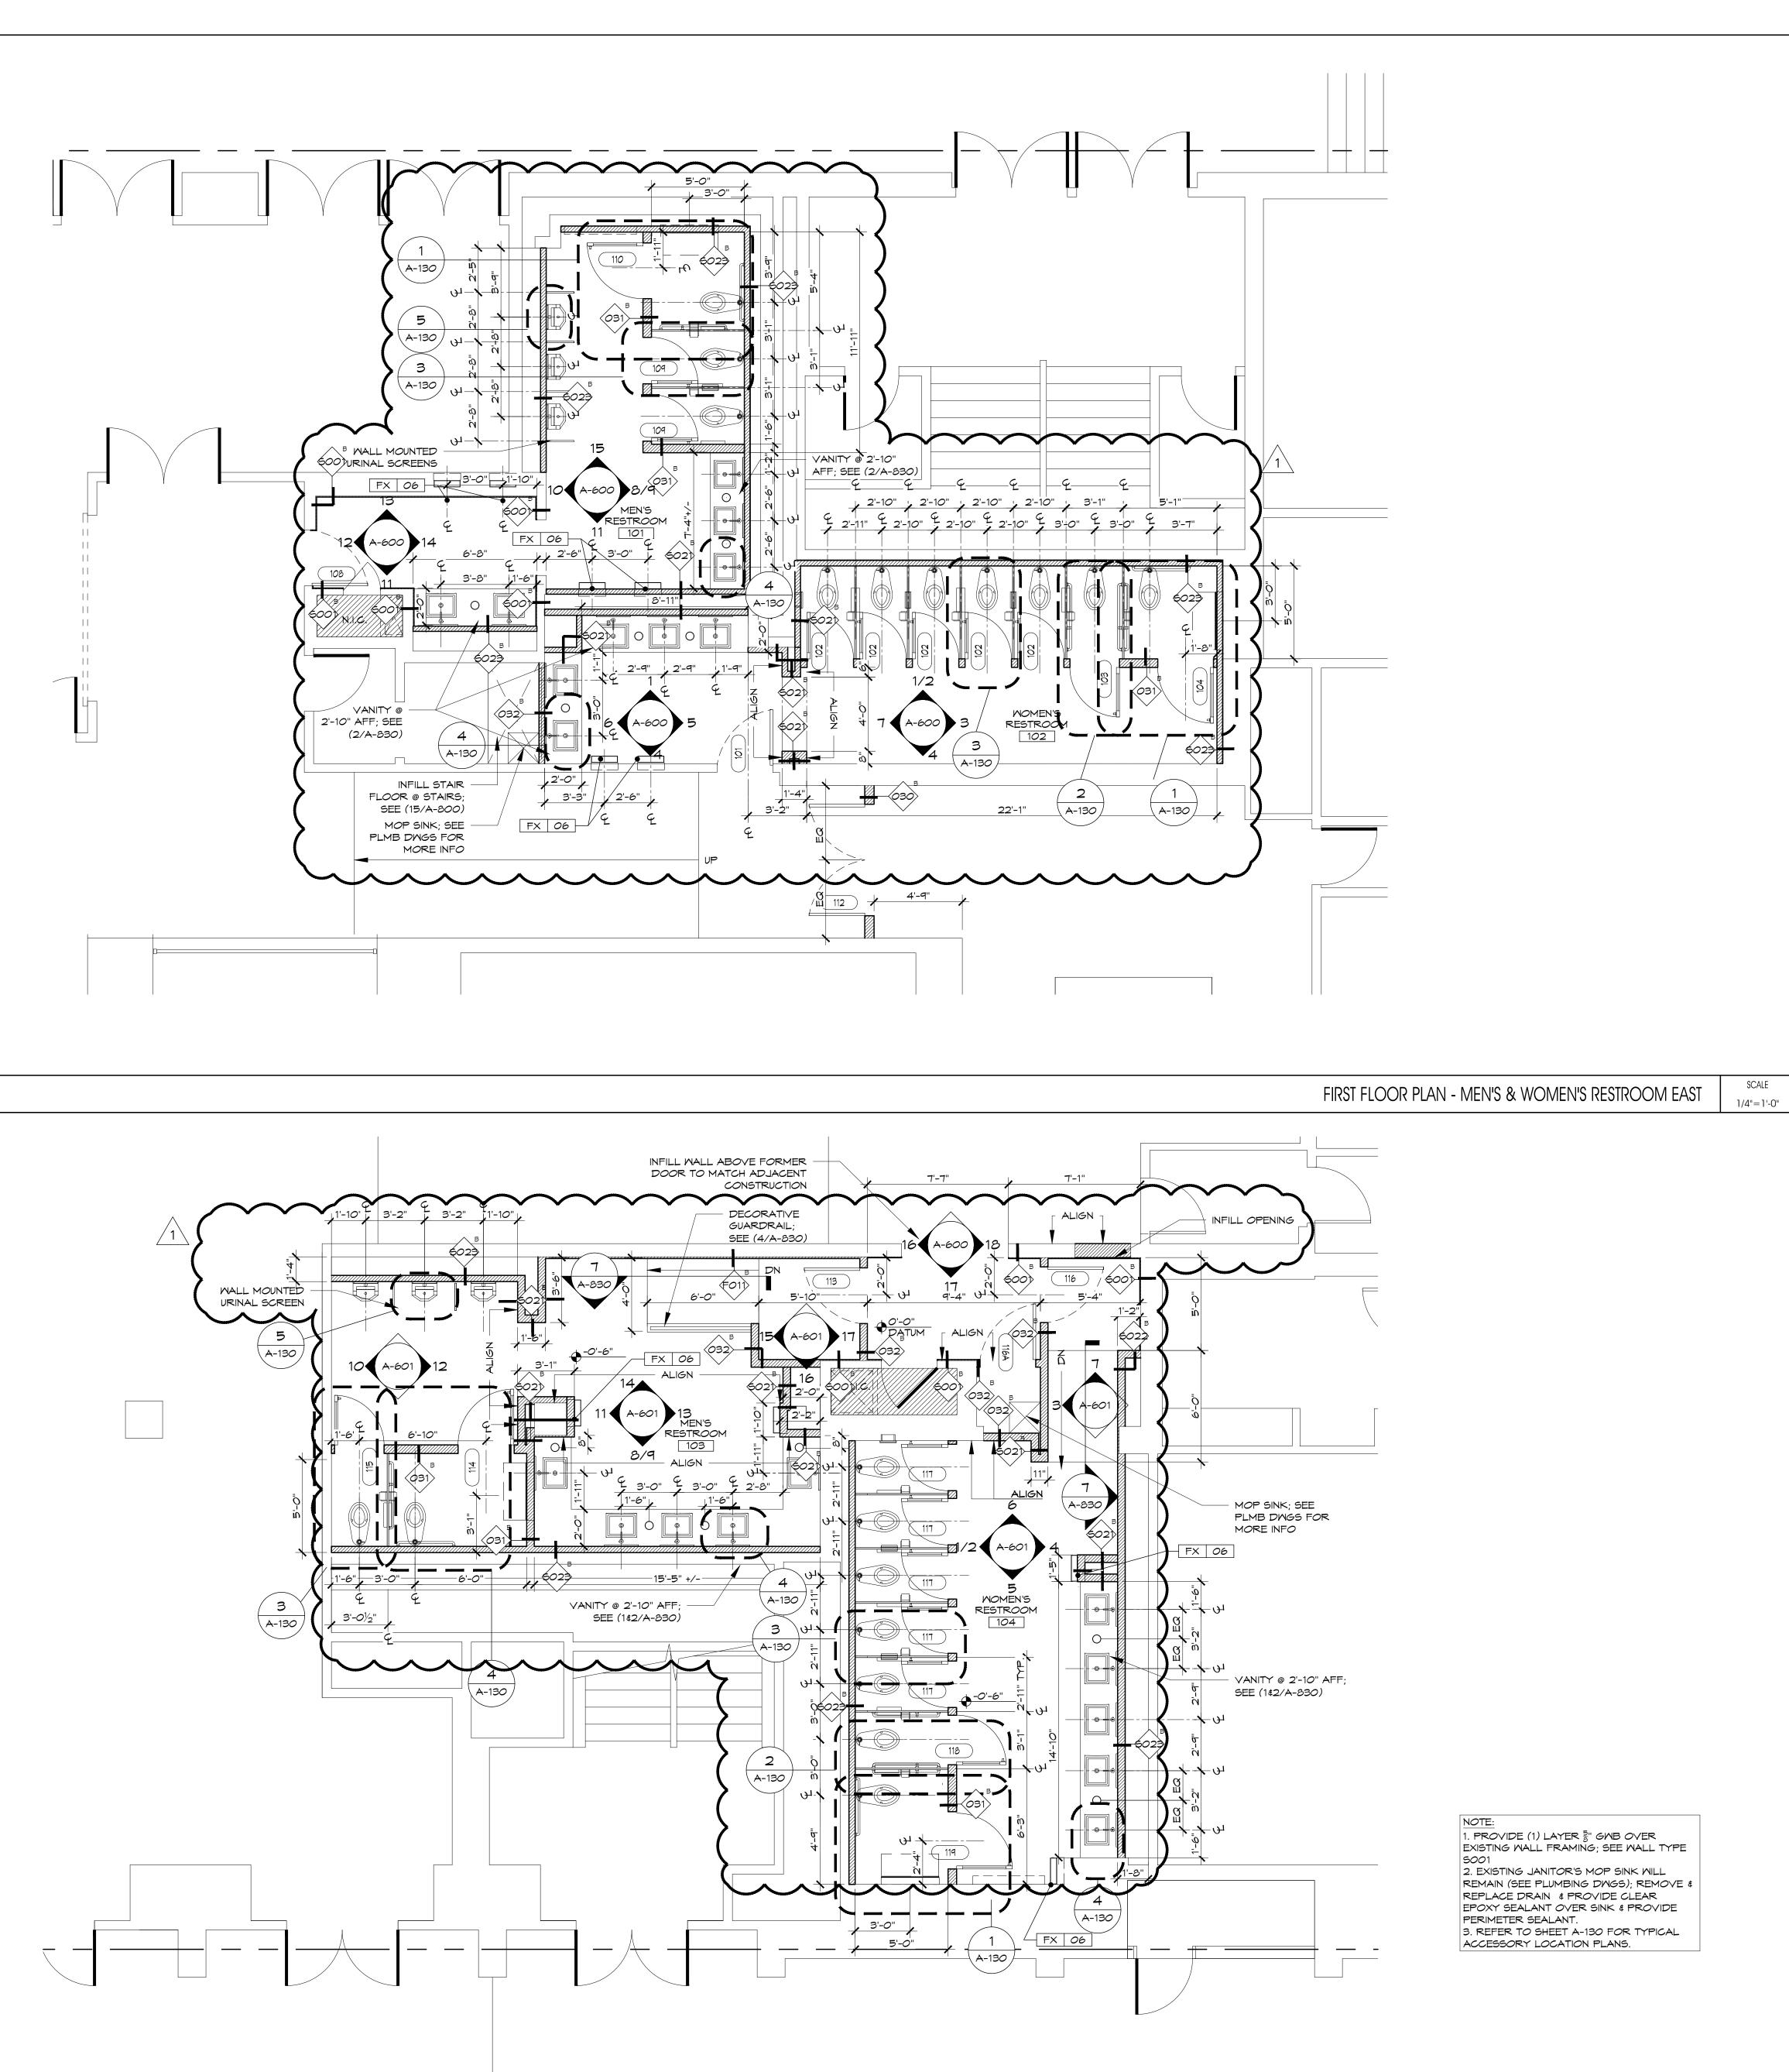




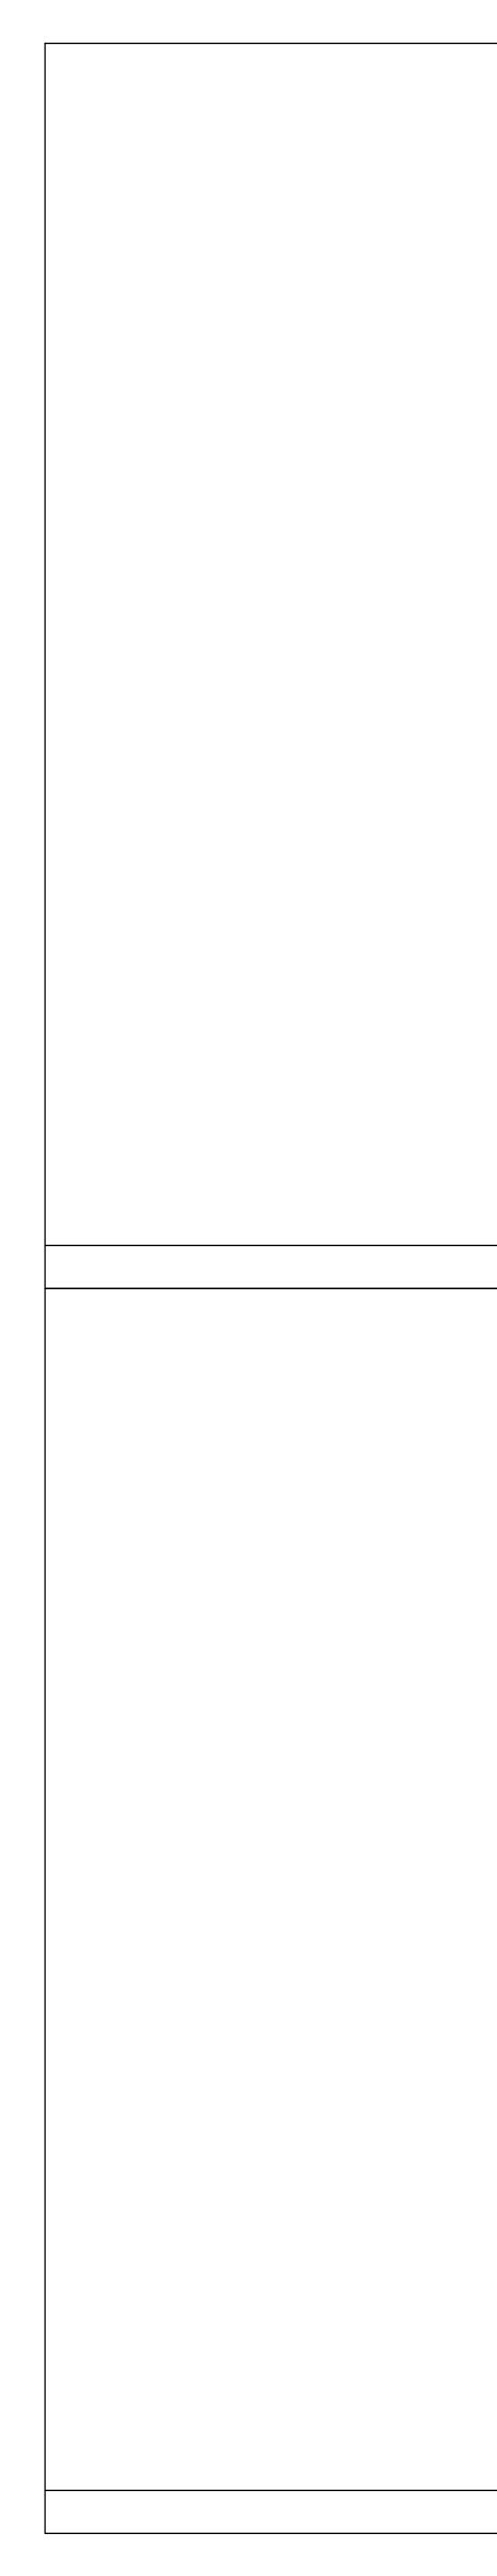

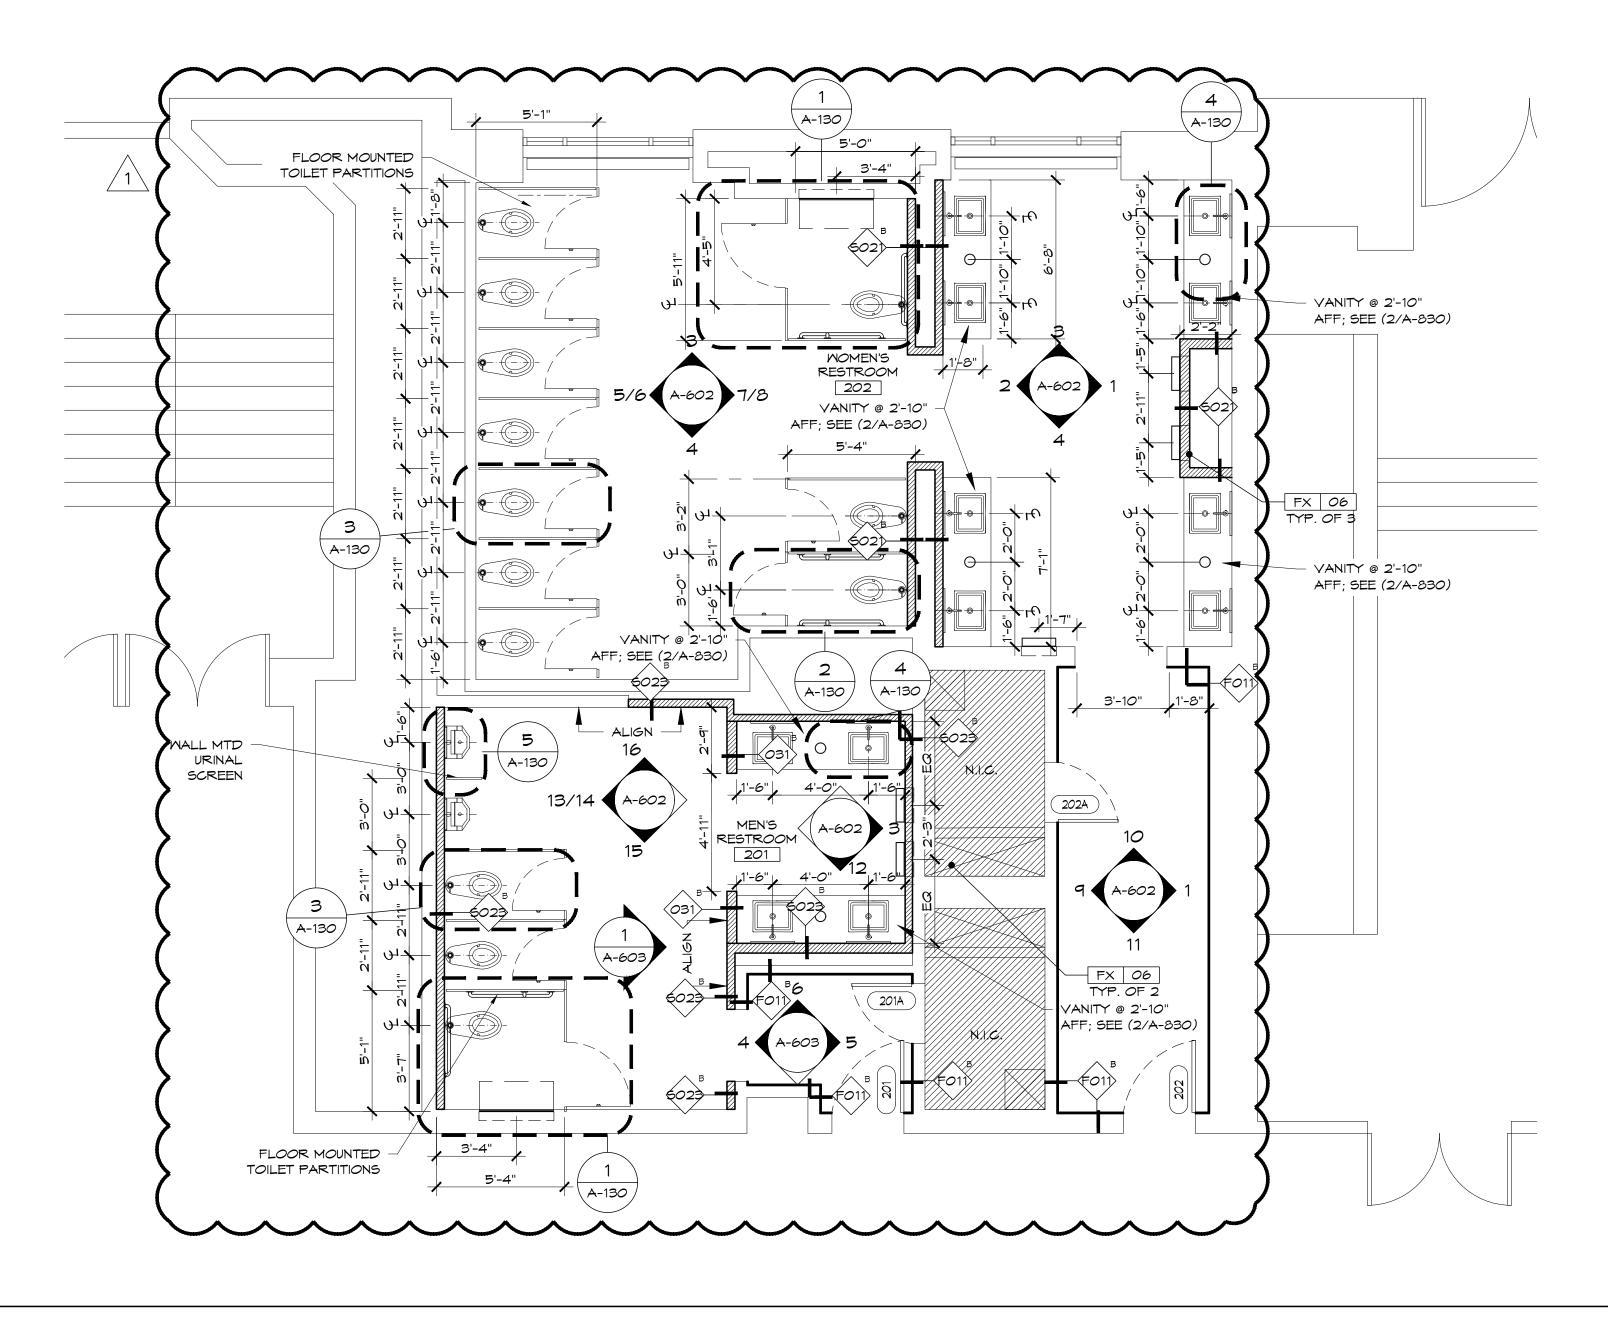

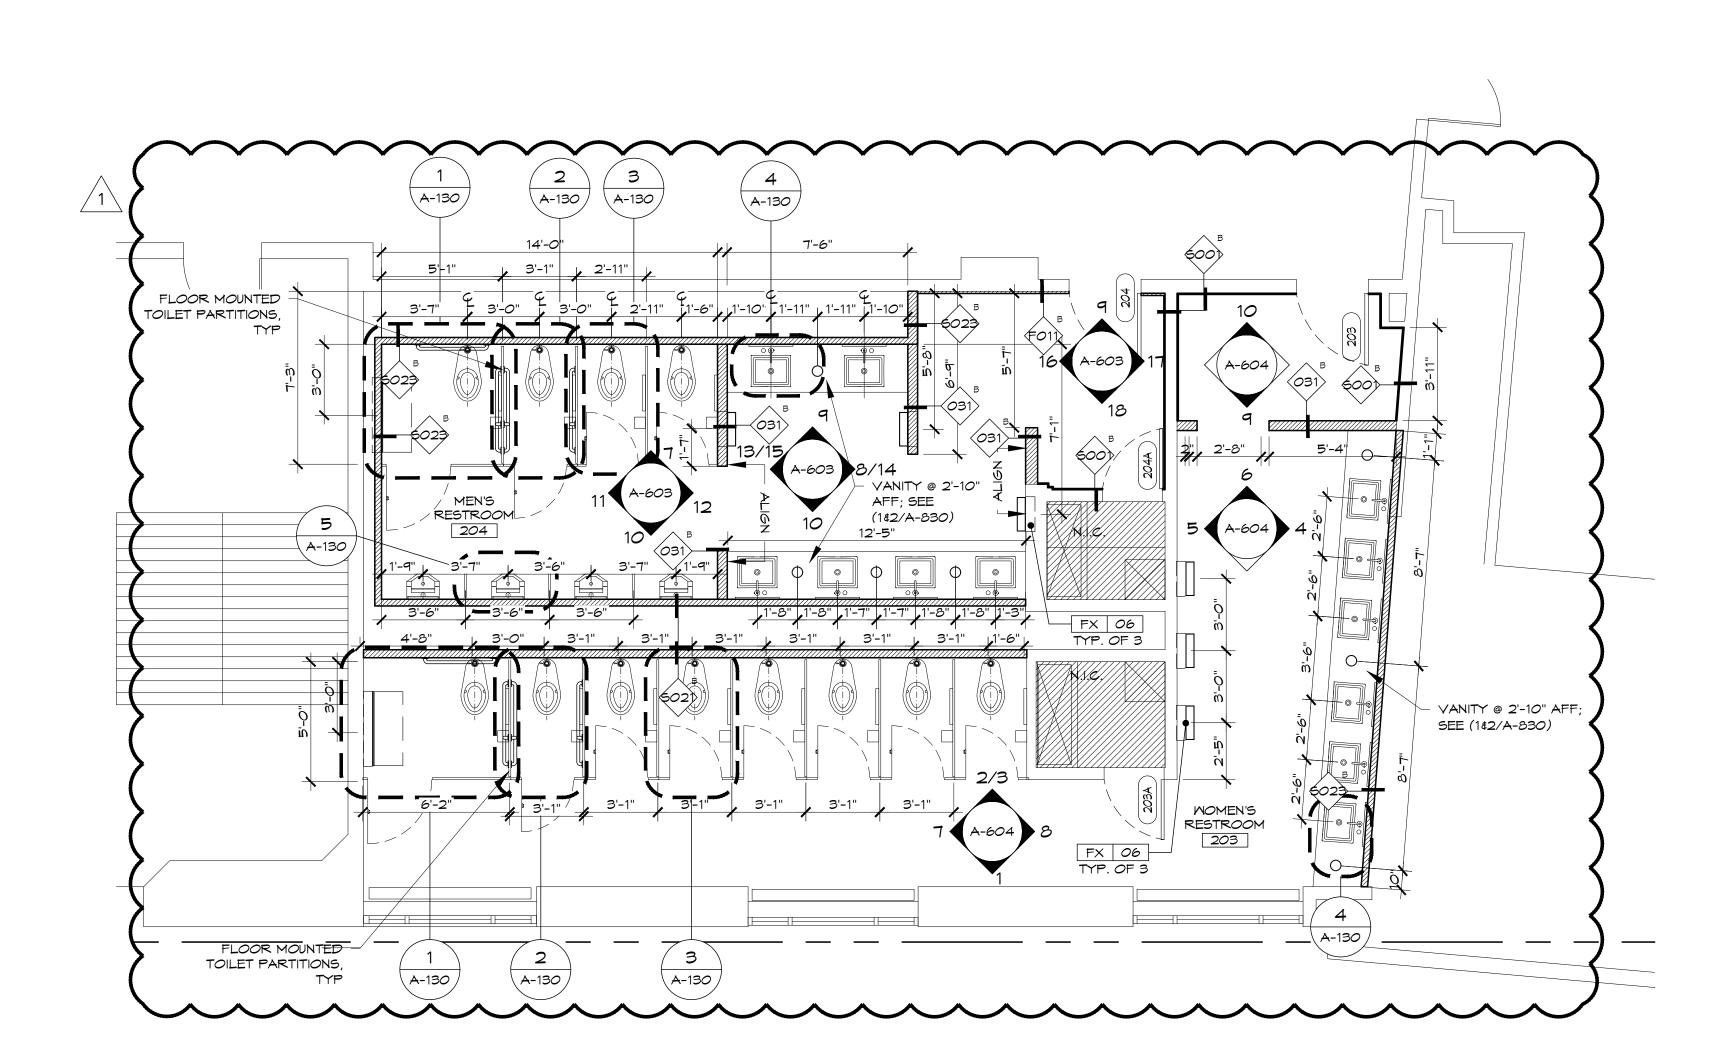


SECOND FLOOR PLAN - MEN'S & WOMEN'S RESTROOM EAST 1/4"=1'-0"

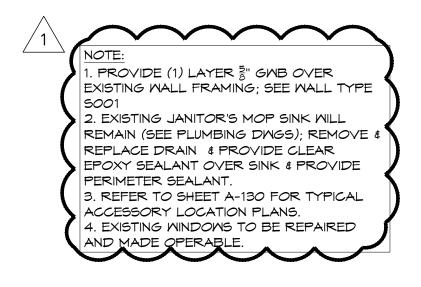





SCALE

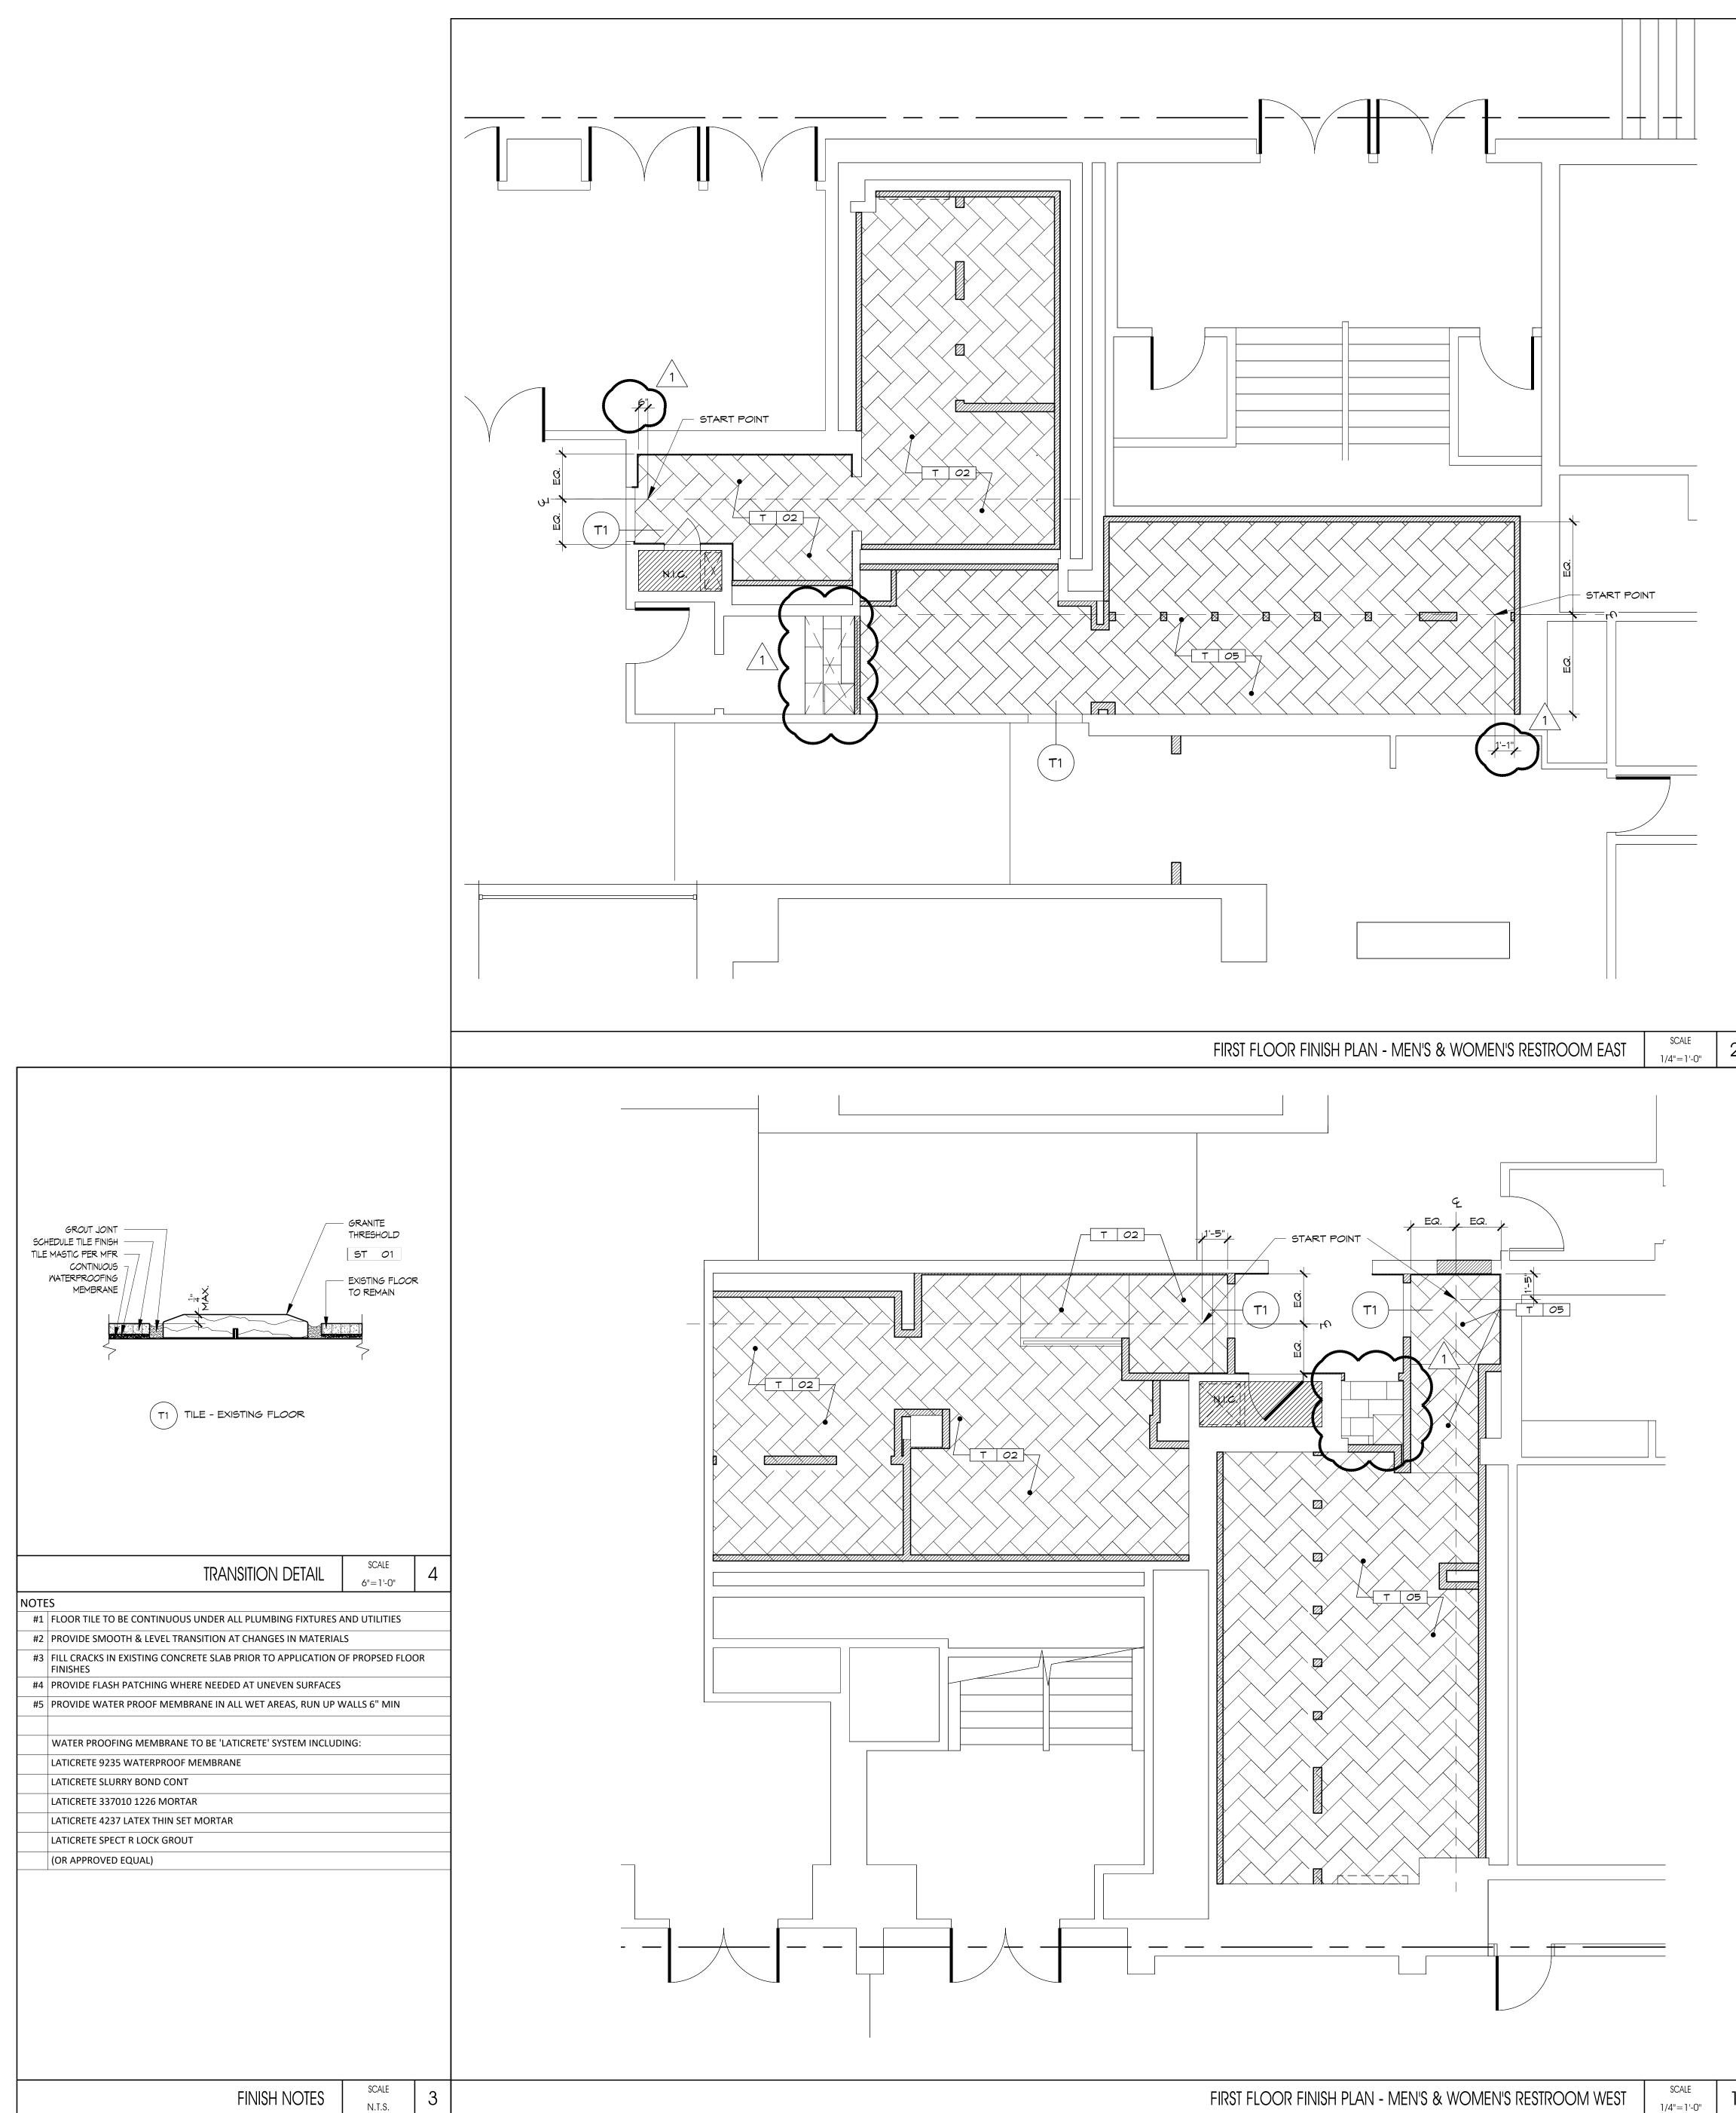

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1 2016.11.30 ADDENDUM #2
NO. DATE: DESCRIPTION:
DRAWING TITLE: FIRST FLOOR RESTROOM FLOOR FINISH PLANS
DRAWN BY: SB DRAWING NO. REVIEWED BY: CM PROJECT NO. 15243.00.001

#1		AND UTILITIES			
#2	PROVIDE SMOOTH & LEVEL TRANSITION AT CHANGES IN MATERIAI	LS			
#3	#3 FILL CRACKS IN EXISTING CONCRETE SLAB PRIOR TO APPLICATION OF PROPSED FLOOR FINISHES				
#4	#4 PROVIDE FLASH PATCHING WHERE NEEDED AT UNEVEN SURFACES				
#5	#5 PROVIDE WATER PROOF MEMBRANE IN ALL WET AREAS, RUN UP WALLS 6" MIN				
	WATER PROOFING MEMBRANE TO BE 'LATICRETE' SYSTEM INCLUD	ING:			
	LATICRETE 9235 WATERPROOF MEMBRANE				
	LATICRETE SLURRY BOND CONT				
	LATICRETE 337010 1226 MORTAR				
	LATICRETE 4237 LATEX THIN SET MORTAR				
	LATICRETE SPECT R LOCK GROUT				
	(OR APPROVED EQUAL)				
	FINISH NOTES	SCALE N.T.S.	3		

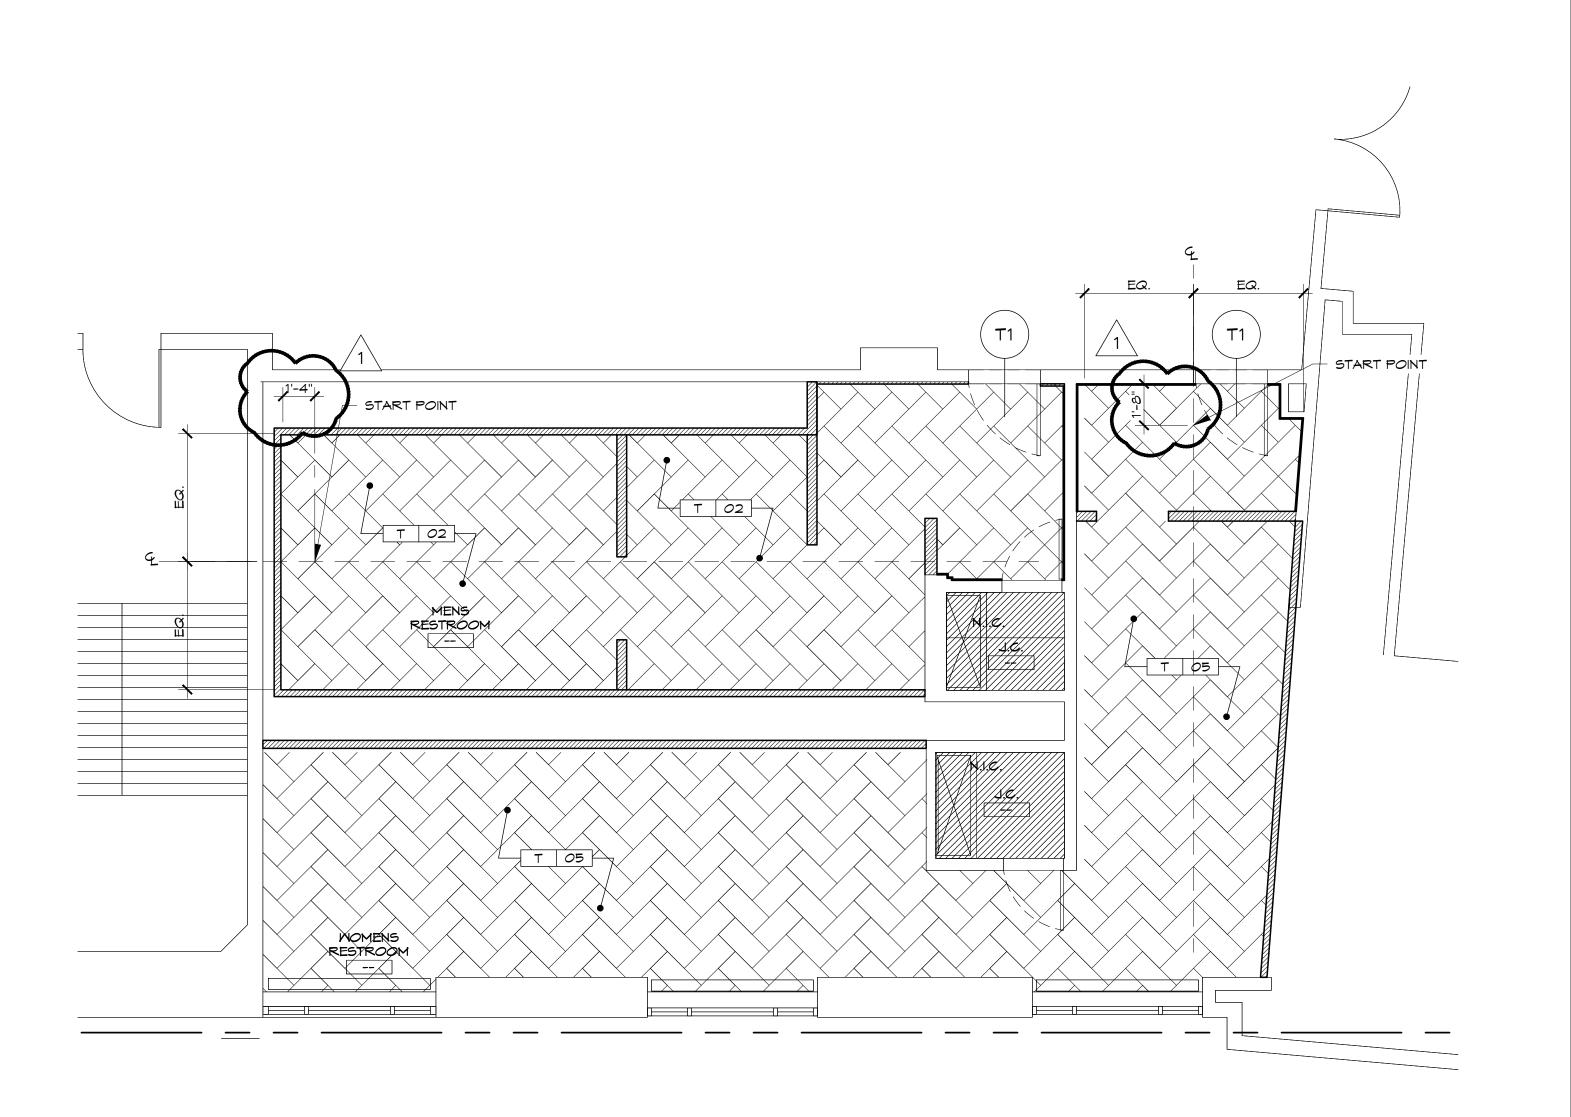


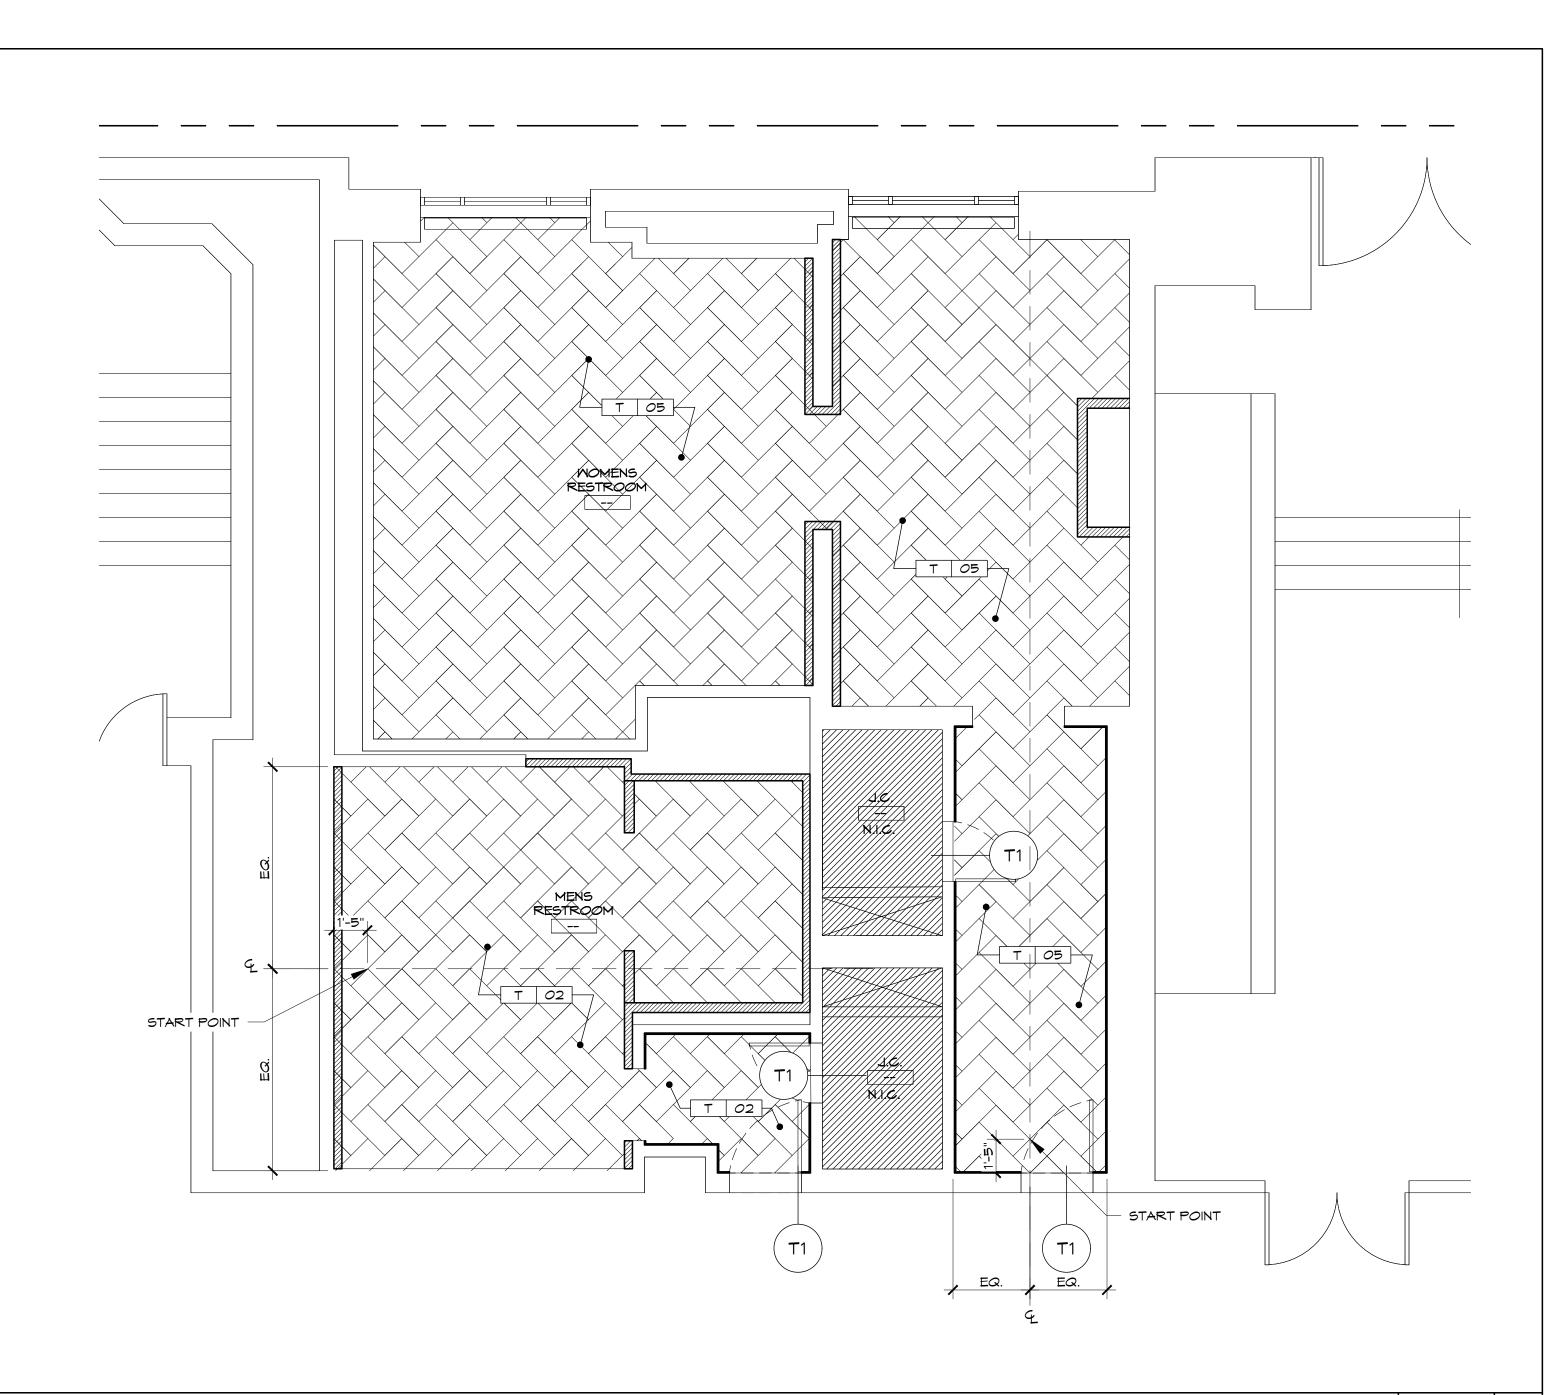



SCALE 1/4"=1'-0"




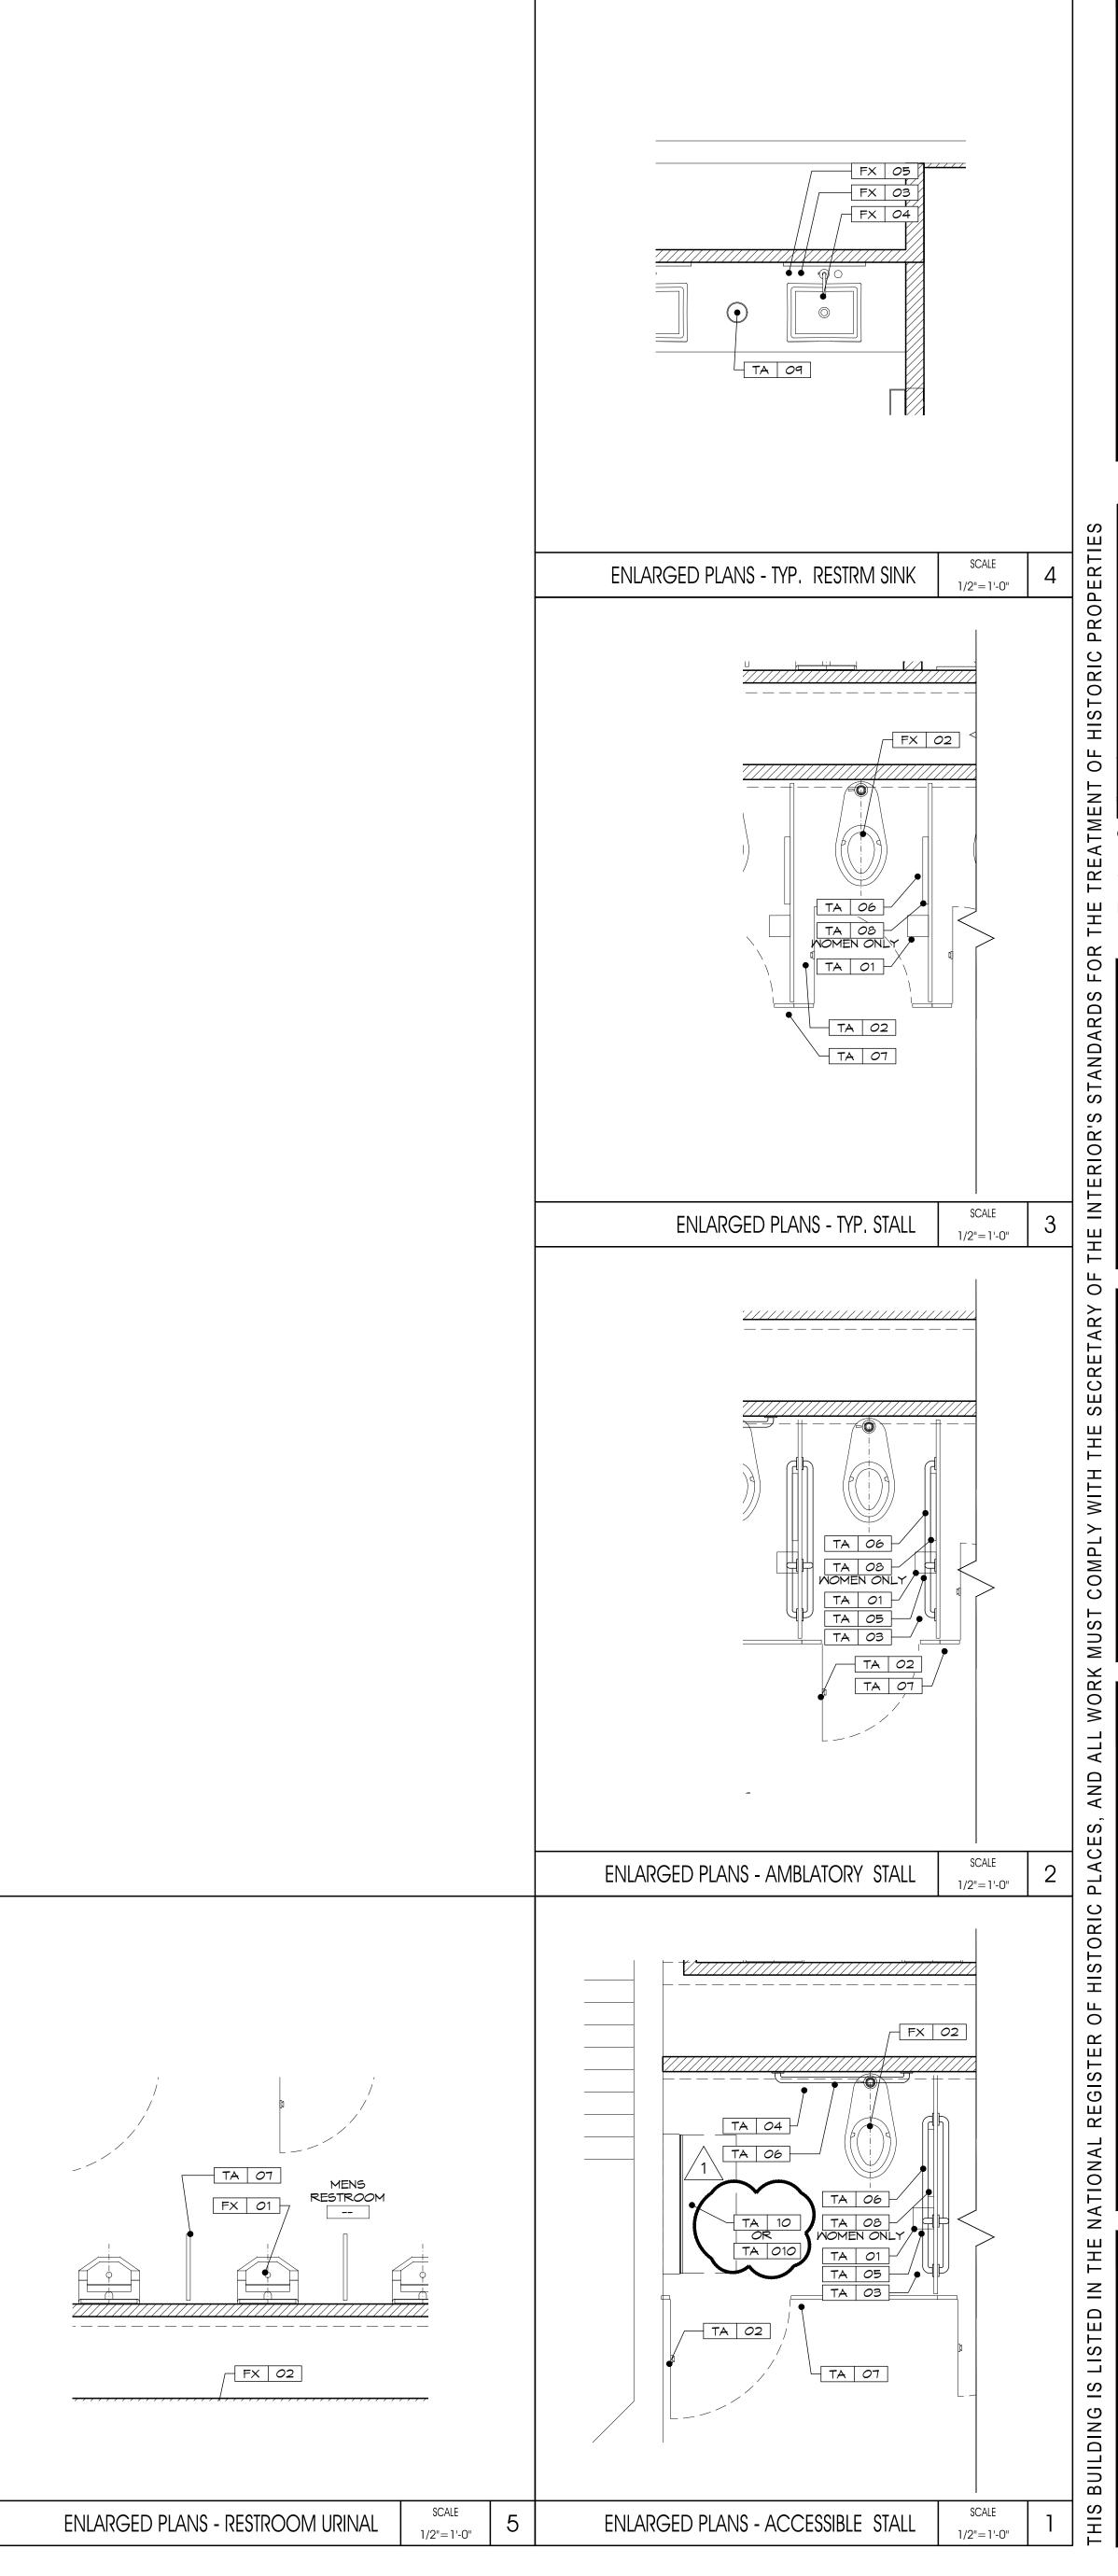




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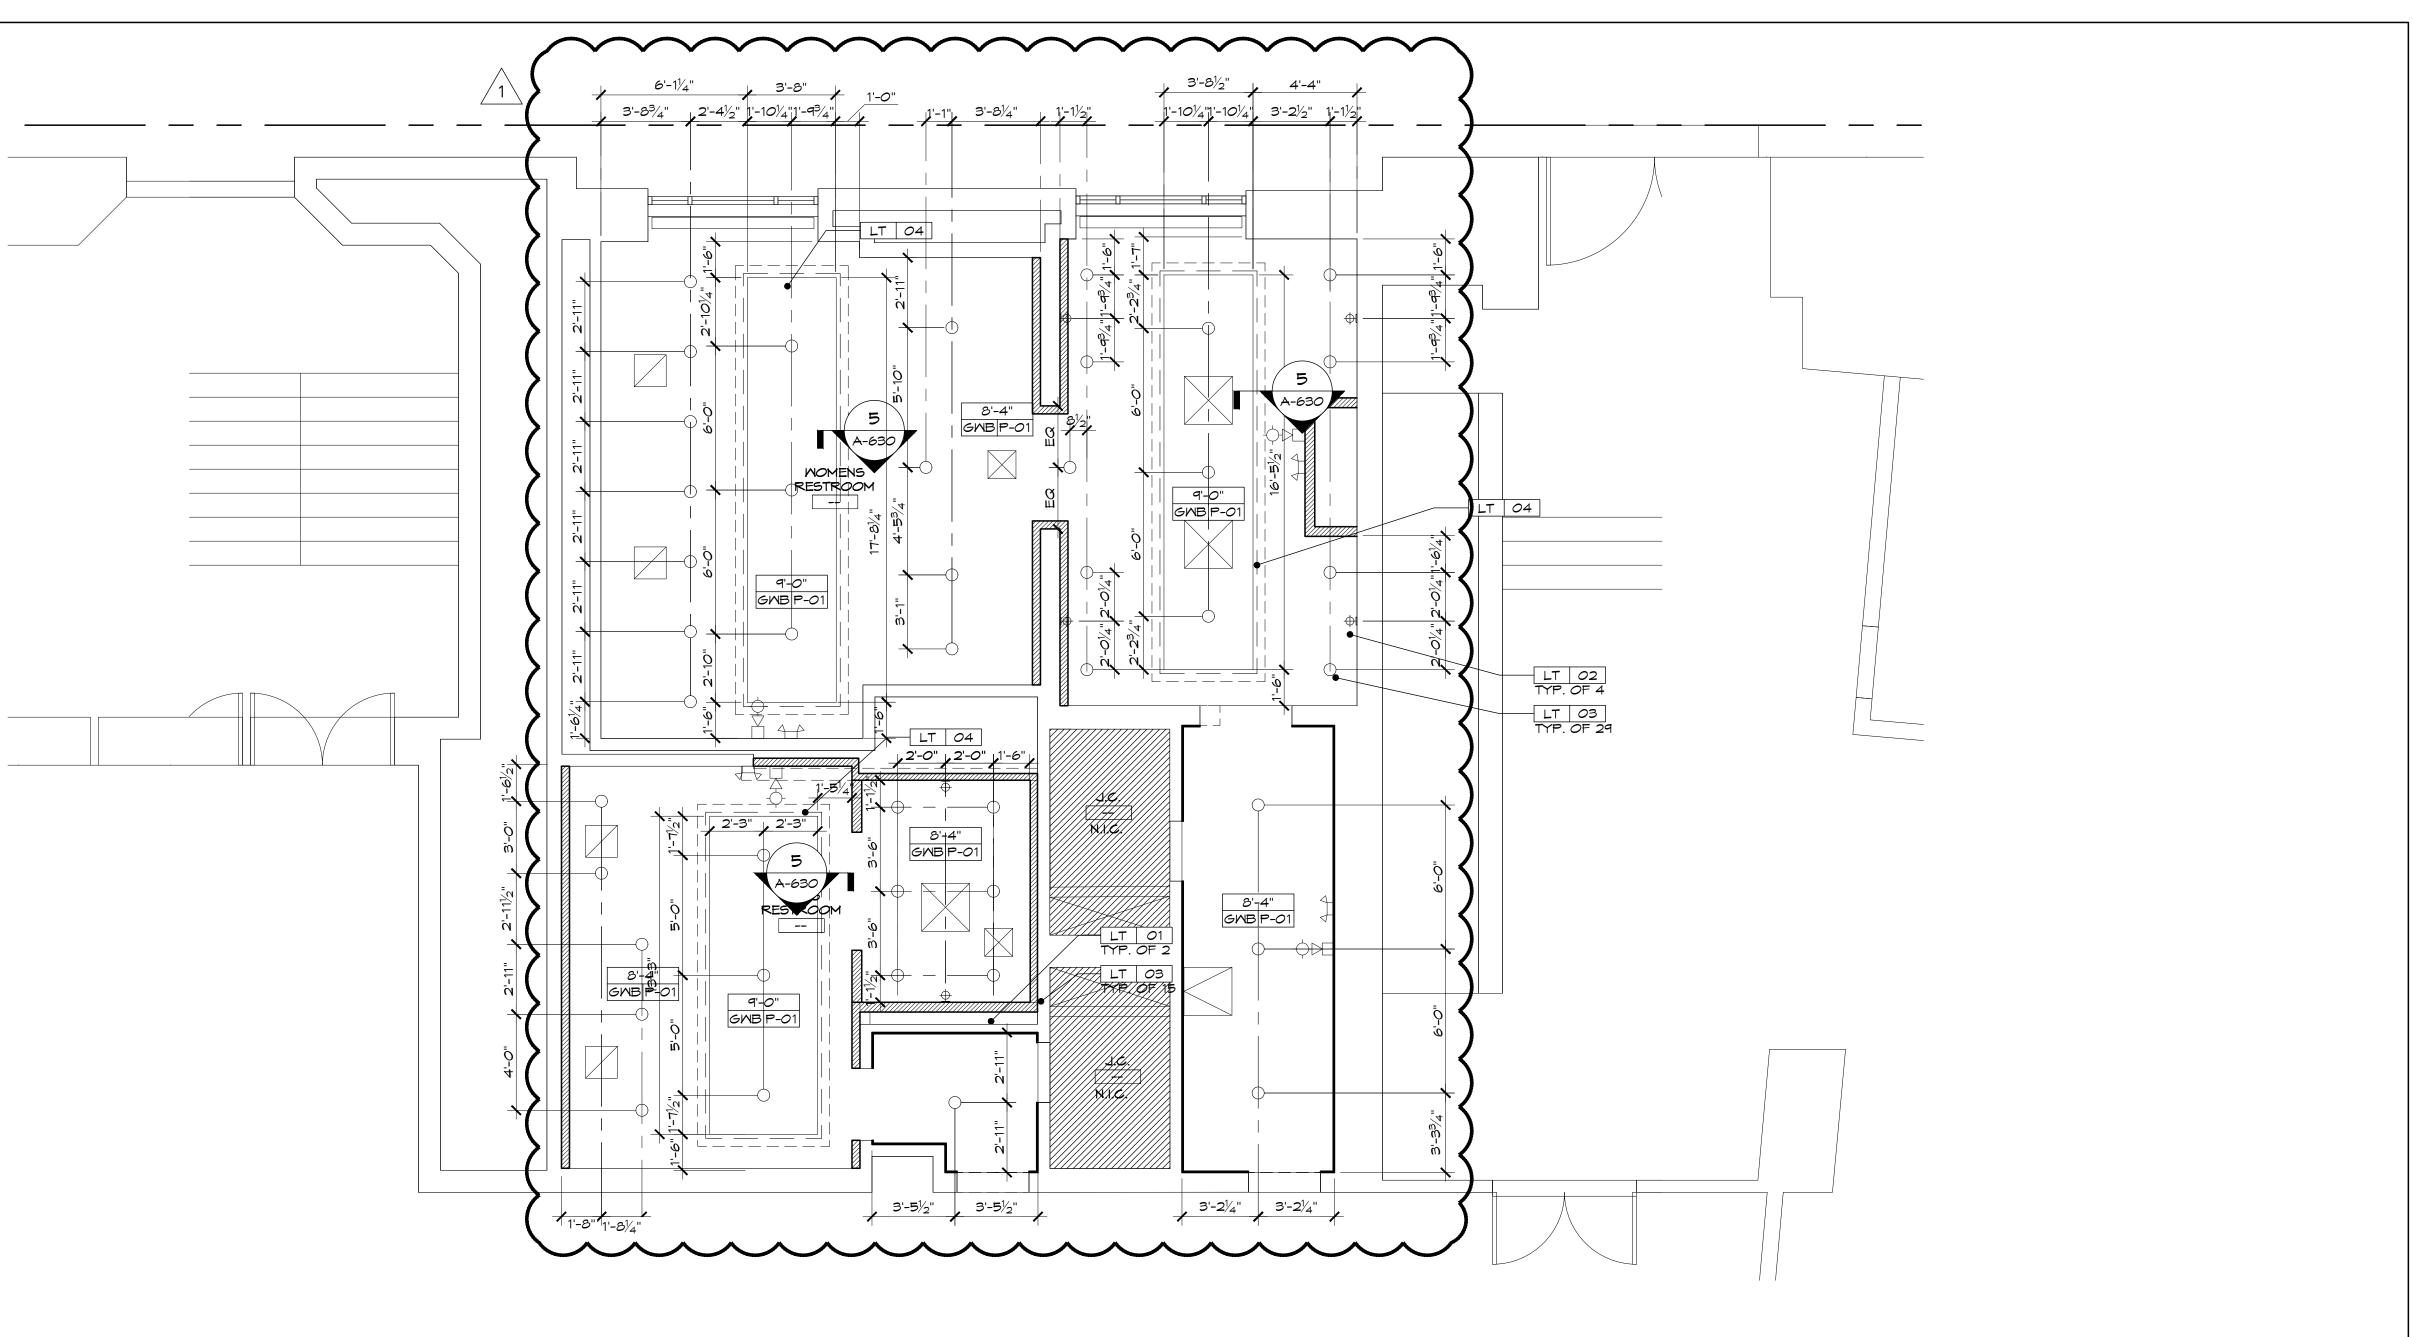
	CEILING LEGEND		
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-\$-D	FIRE ALARM	1	
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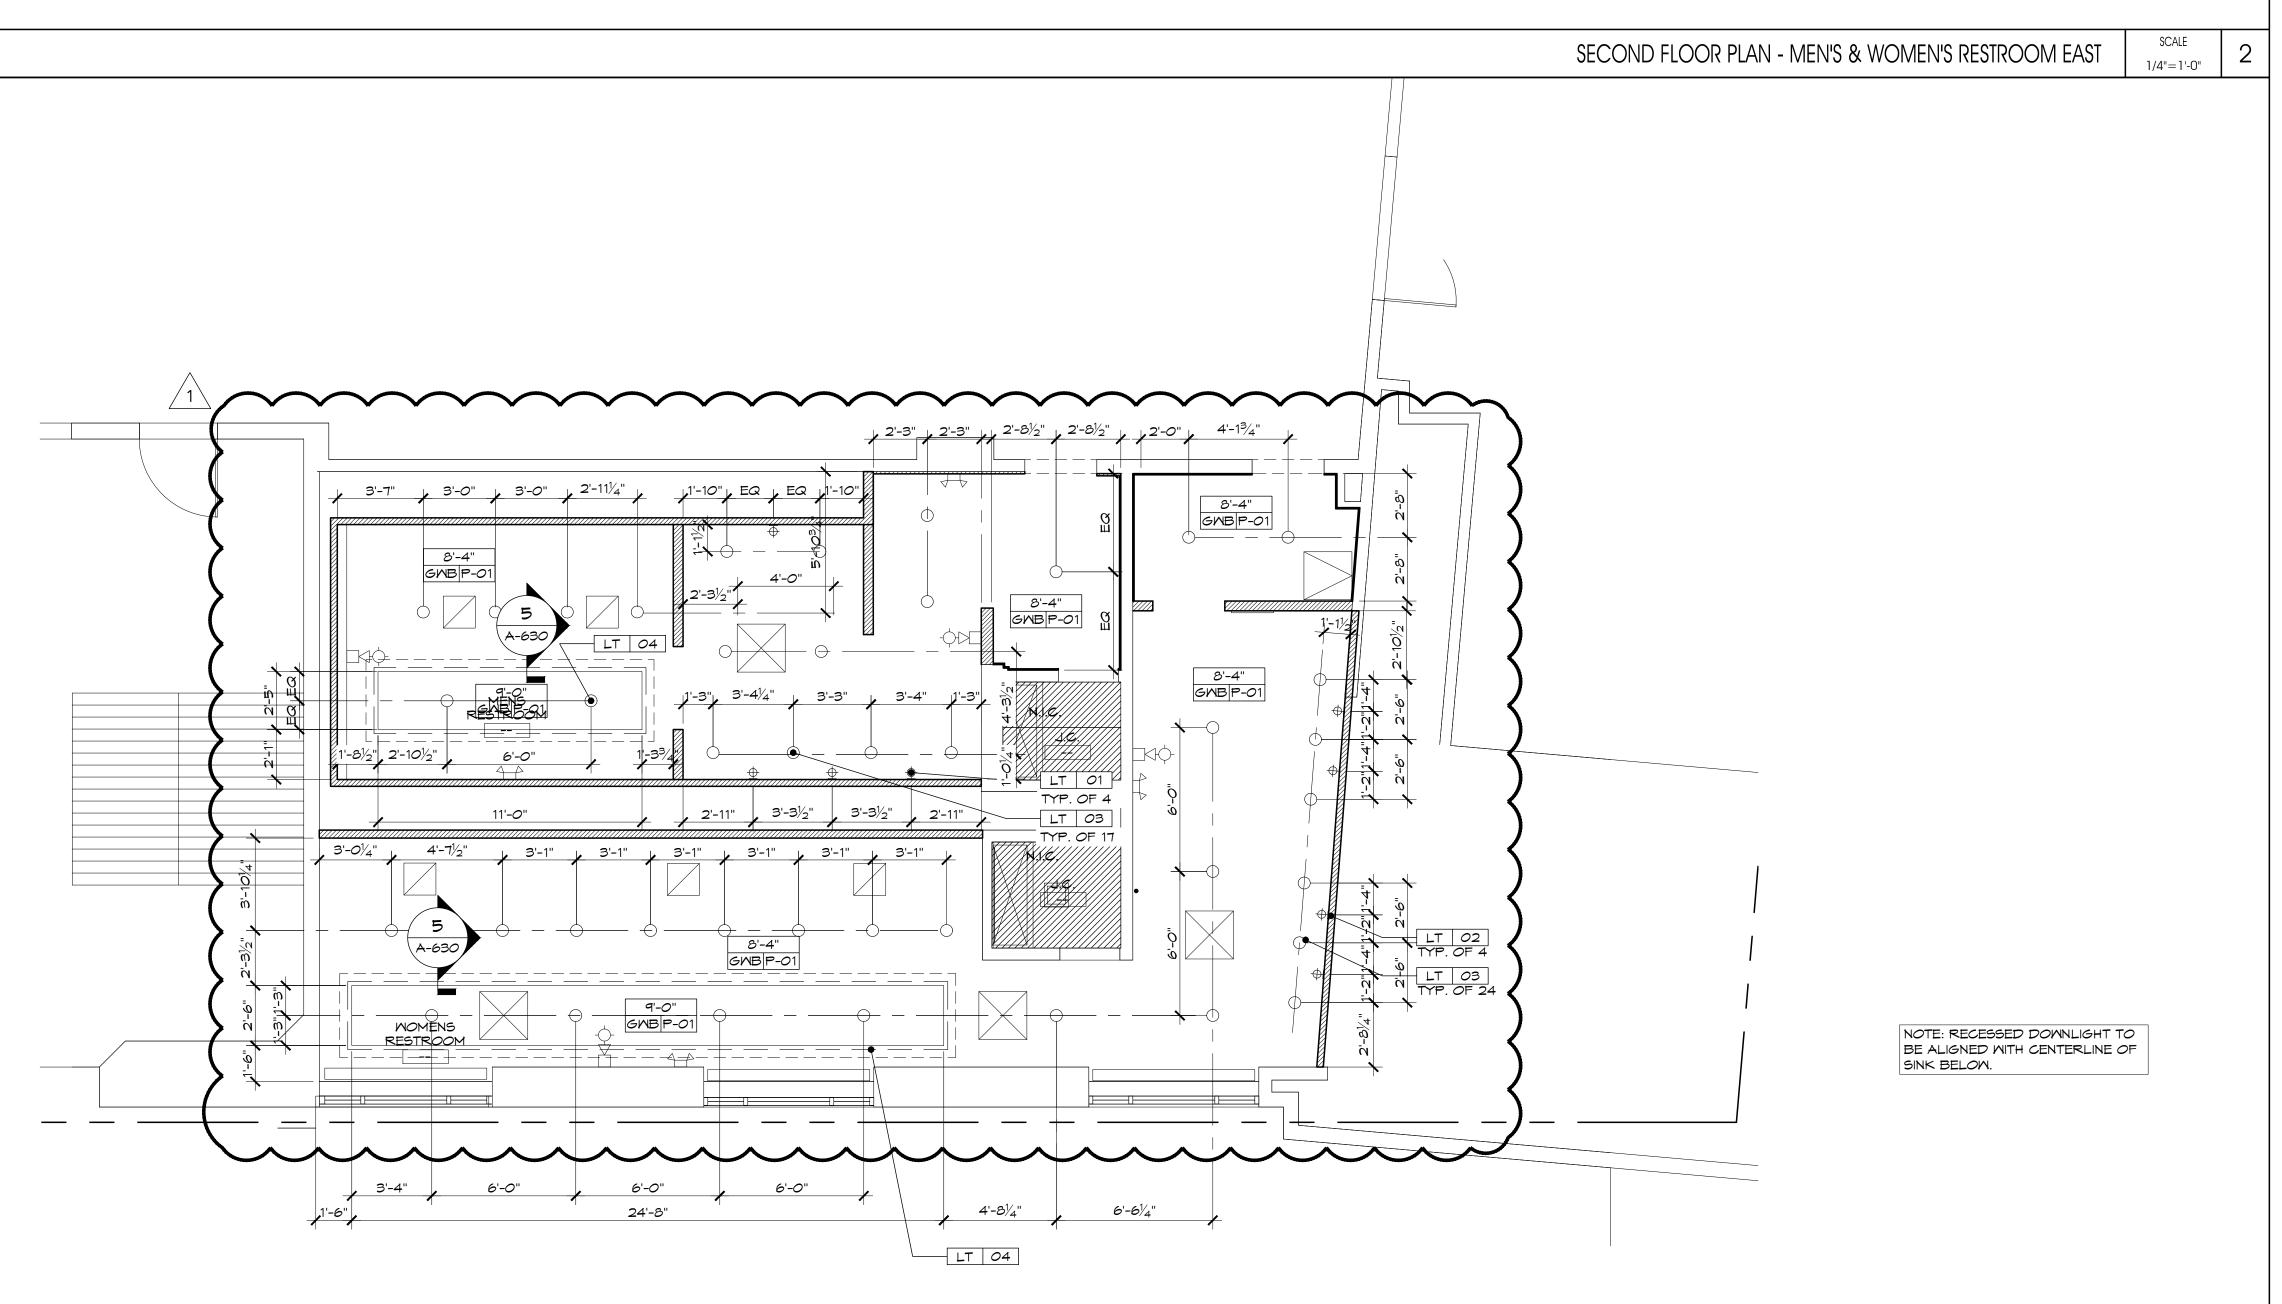


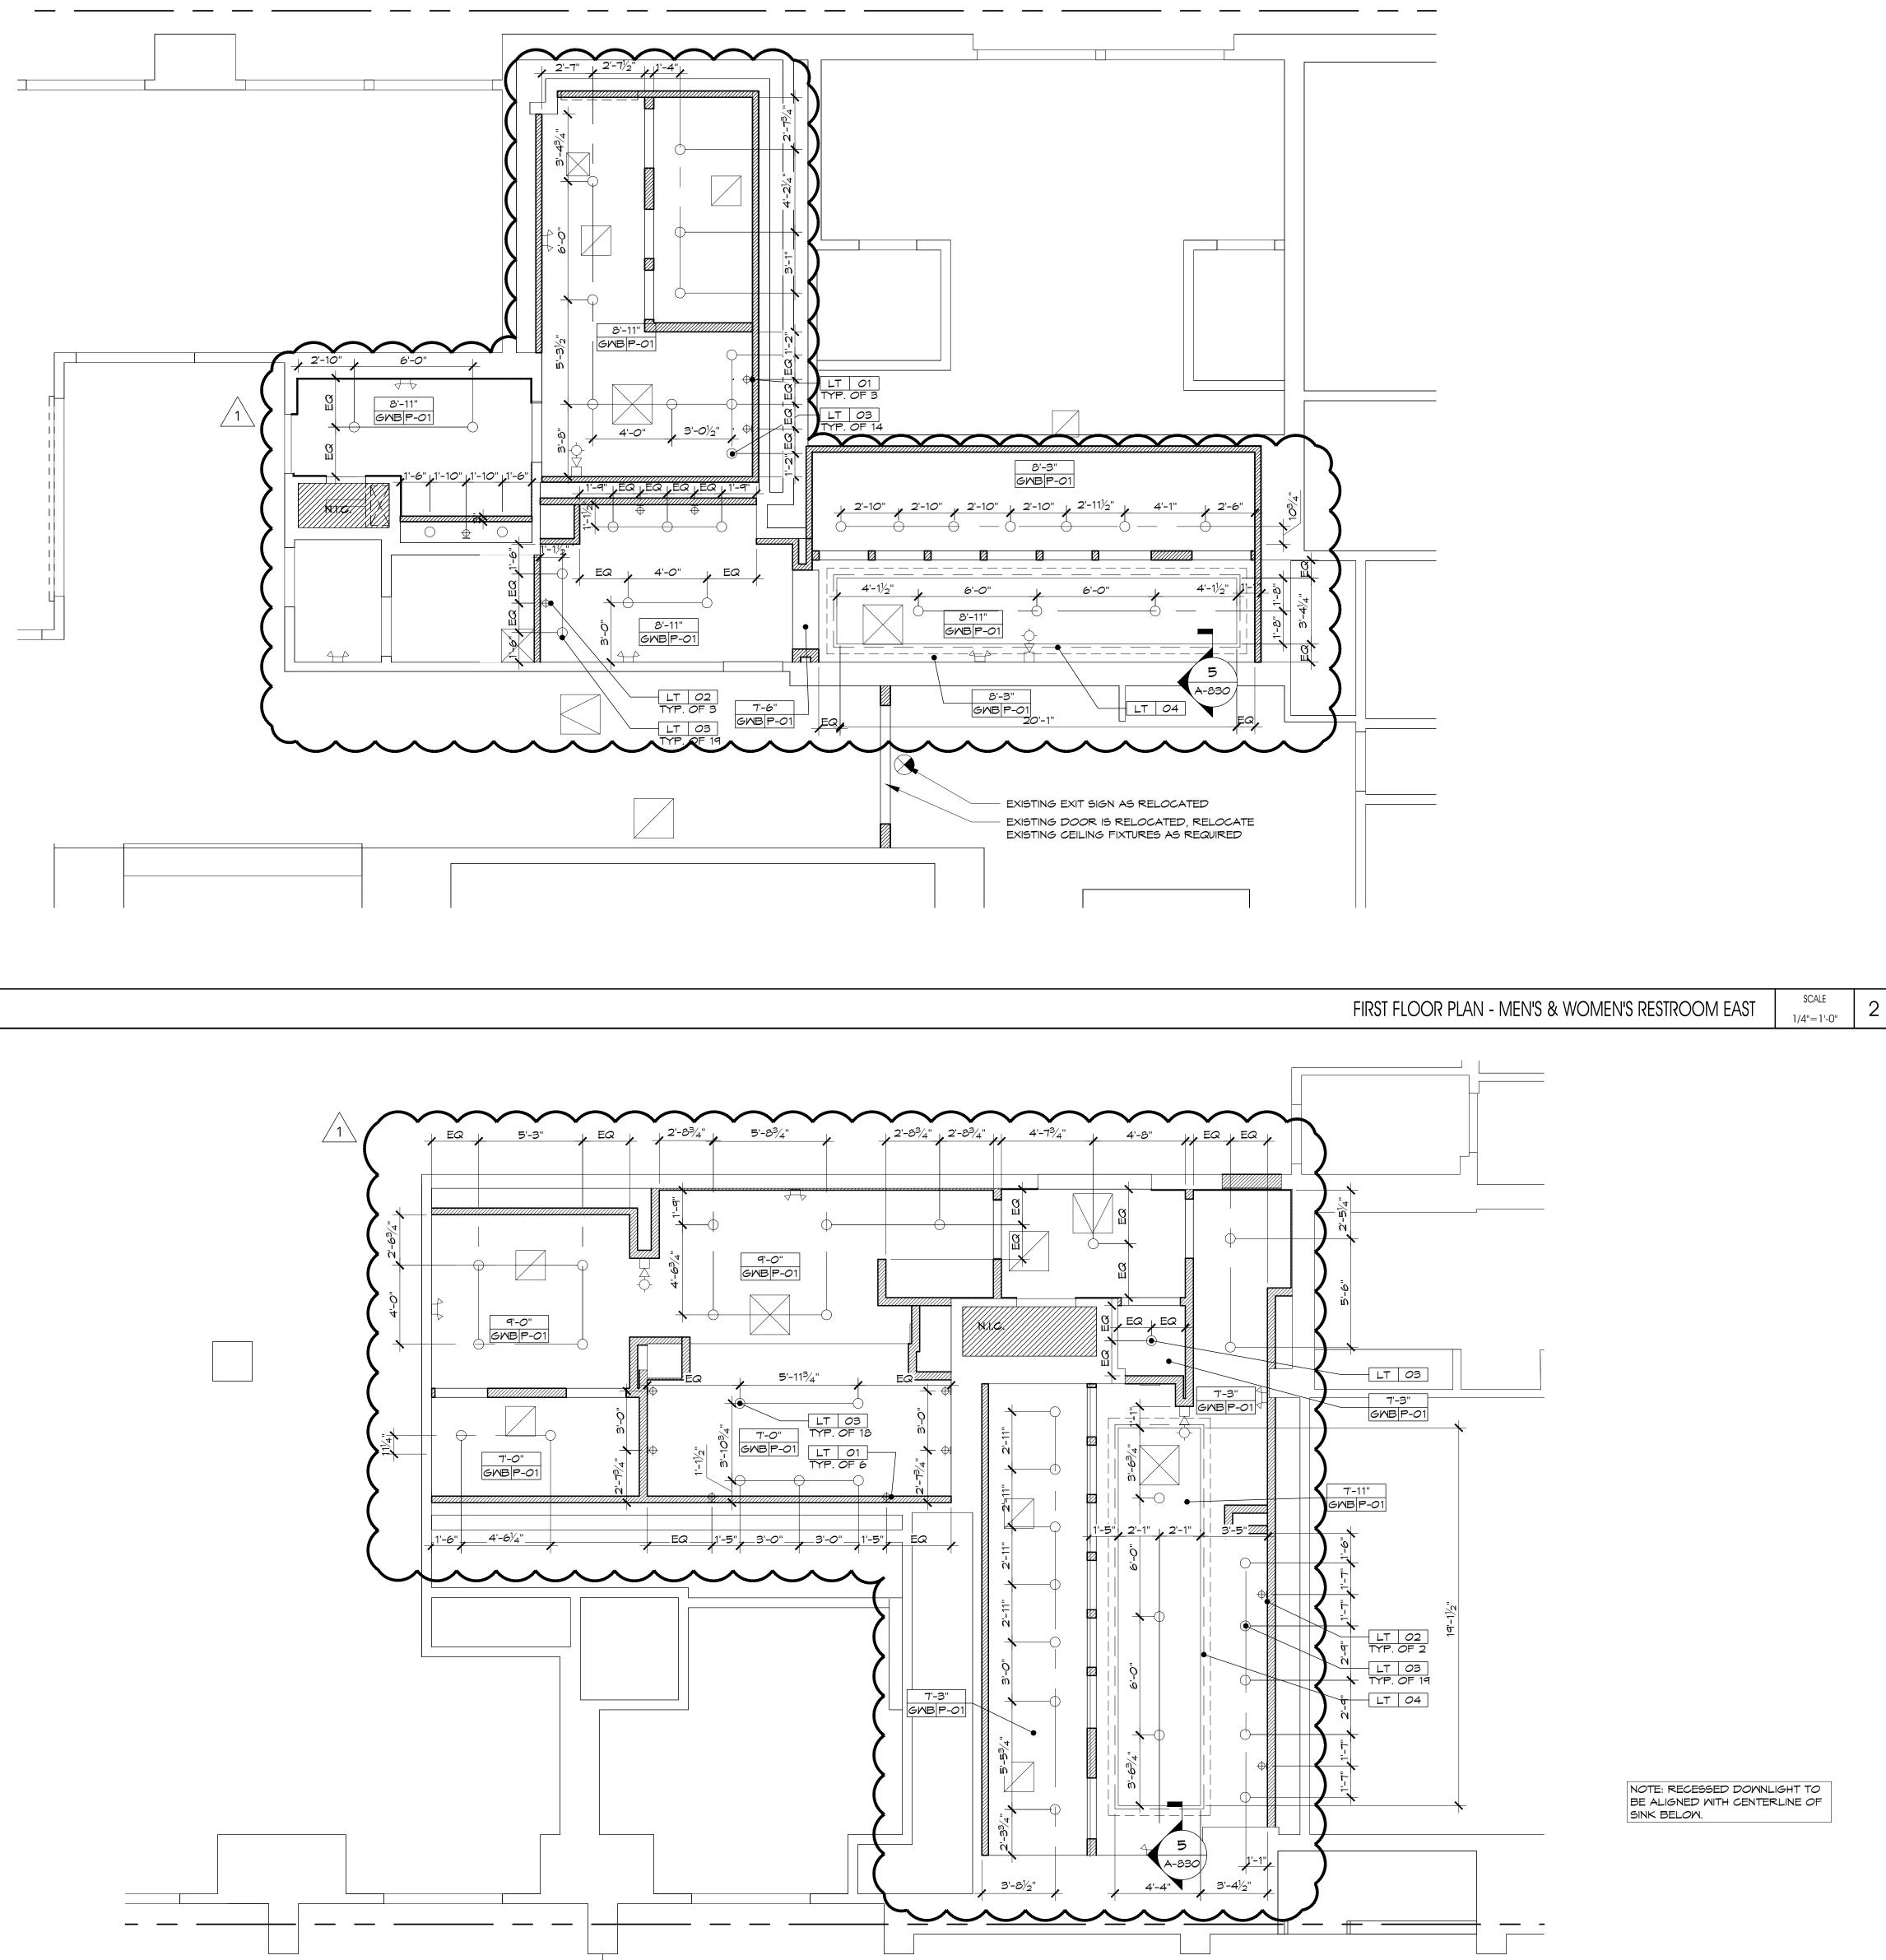


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1 2016.11.30 ADDENDUM #2
I 10-14-2016 I CONSTRUCTION DOCUMENTS NO. I DATE: I DESCRIPTION:
DRAWING TITLE: FIRST FLOOR CEILING PLANS
DRAWN BY: SB DRAWING NO. REVIEWED BY: CM
PROJECT NO. 15243.00.001 A-201

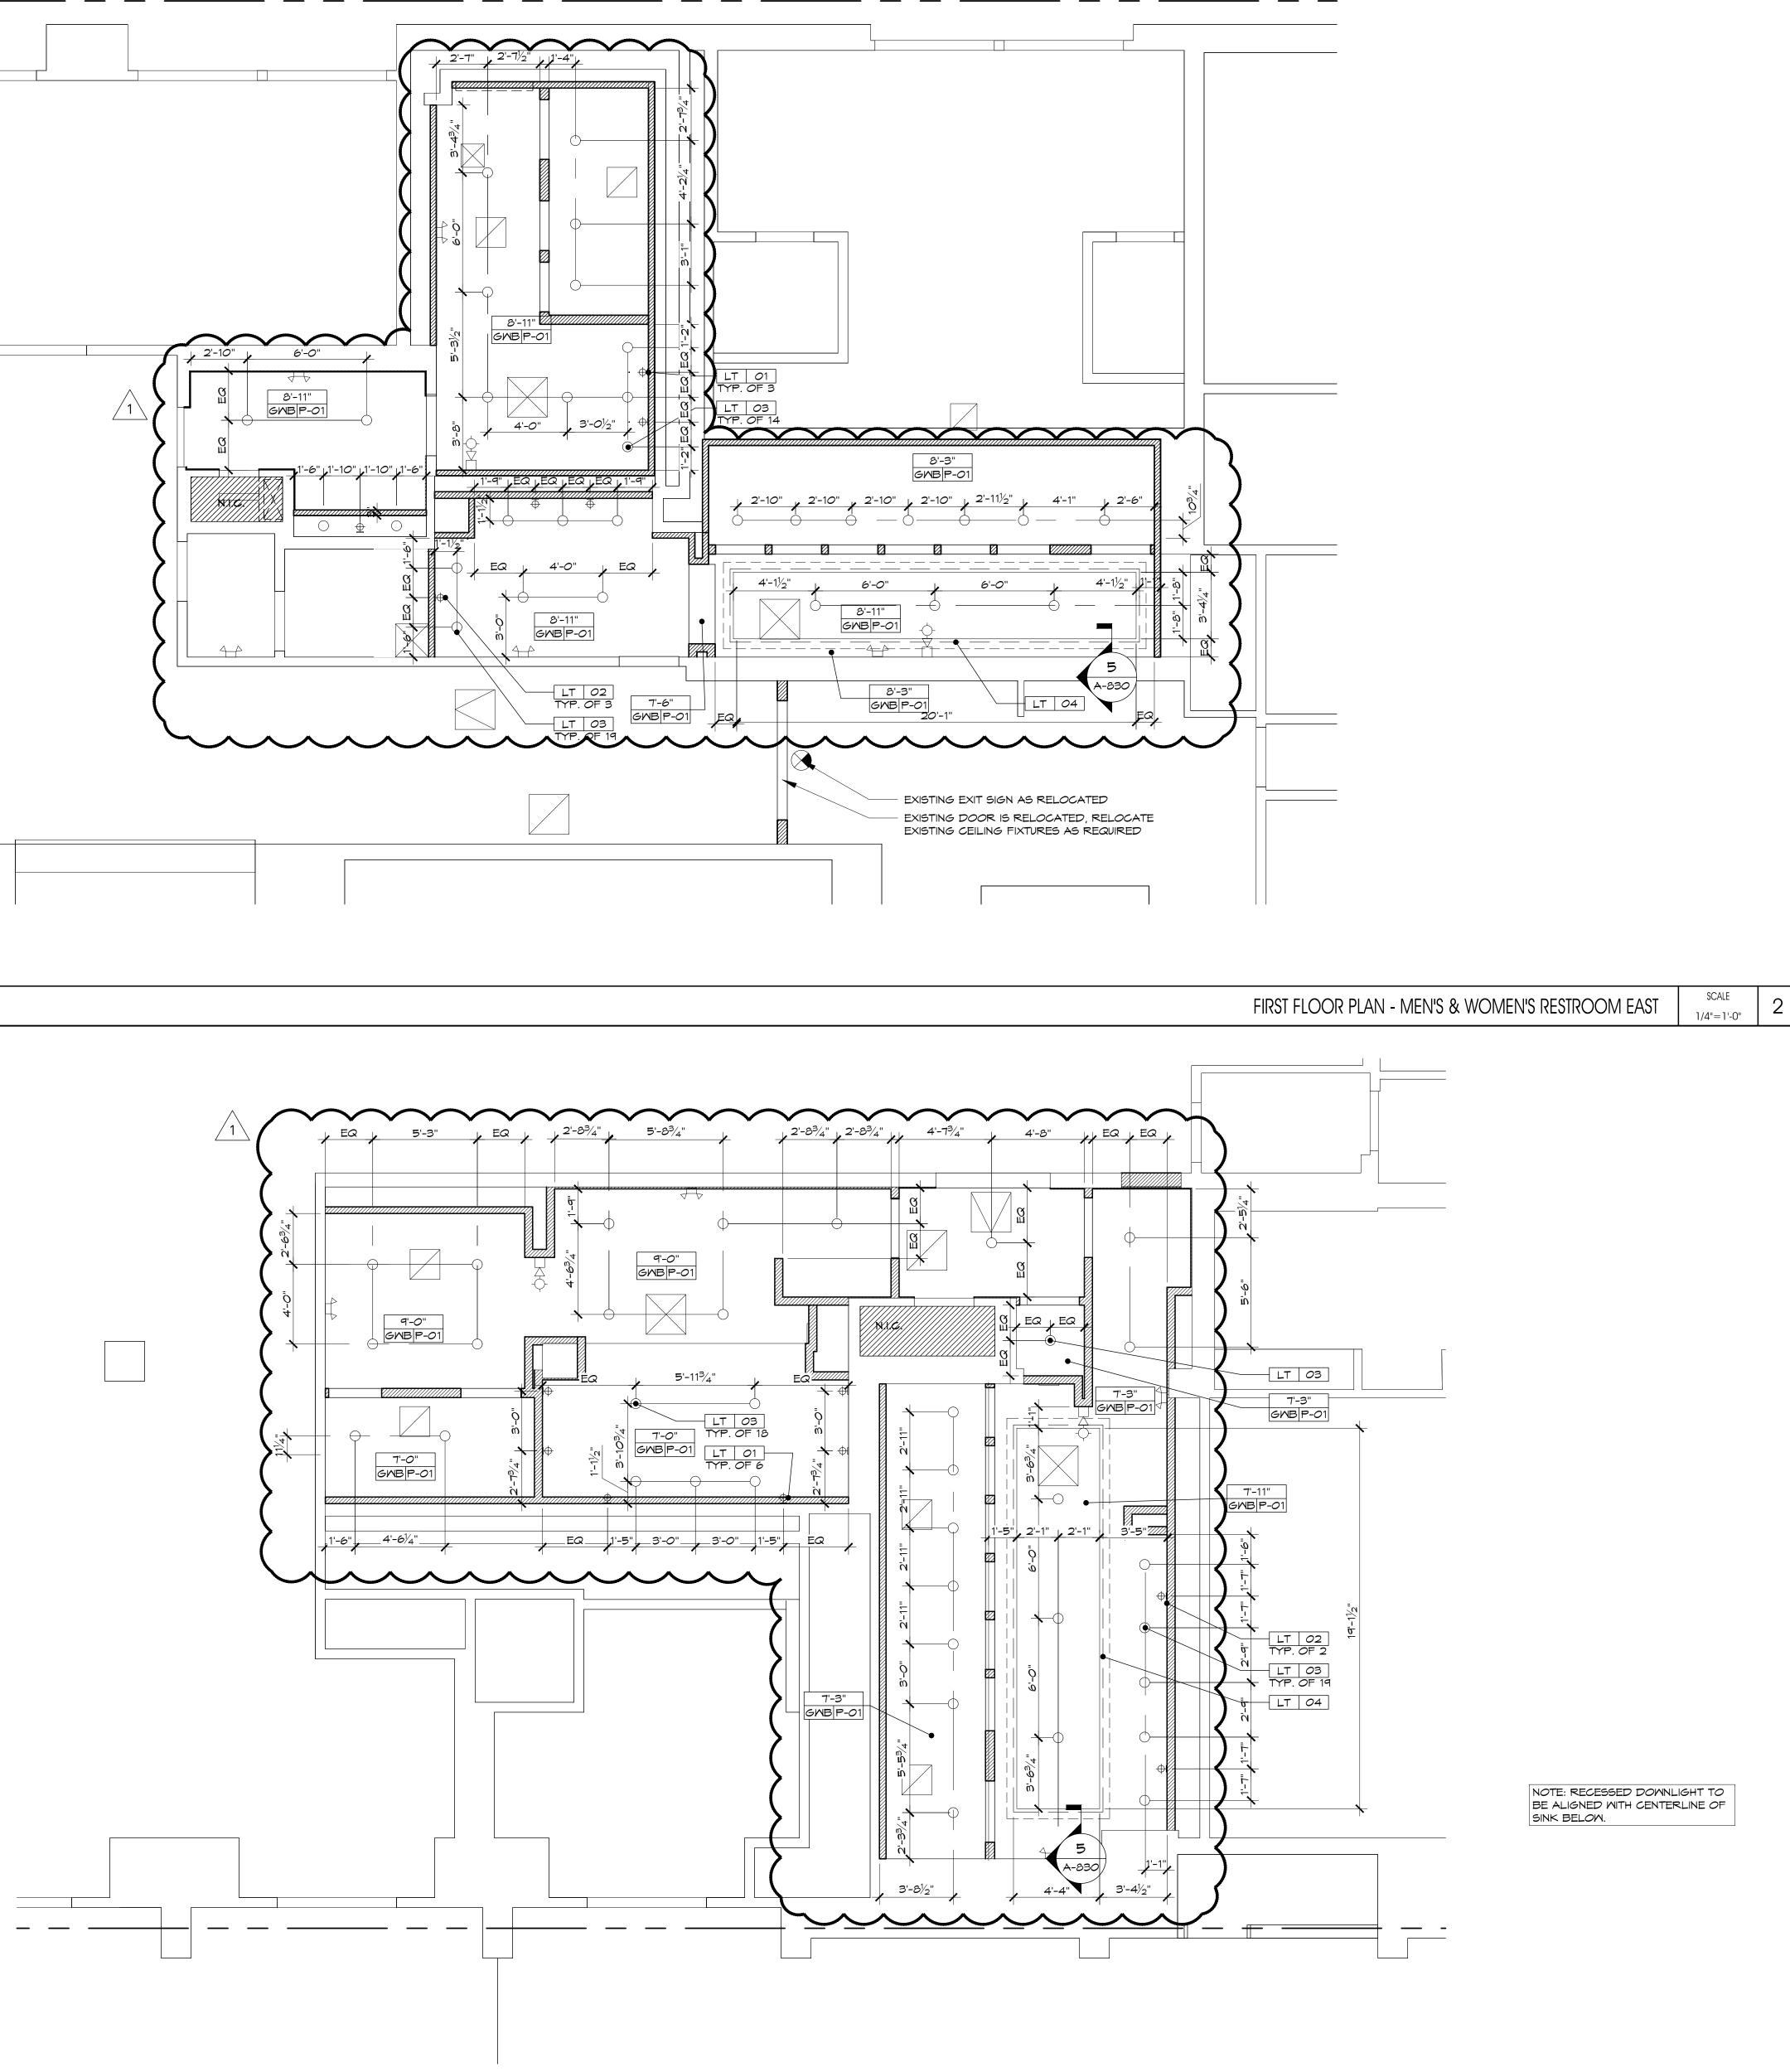
	CEILING LEGEND SCONCE	
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	APPLICABLE)	-
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	RETURN DIFFUSER ACCESS PANEL	
	CEILING LEGEND SCALE 3	
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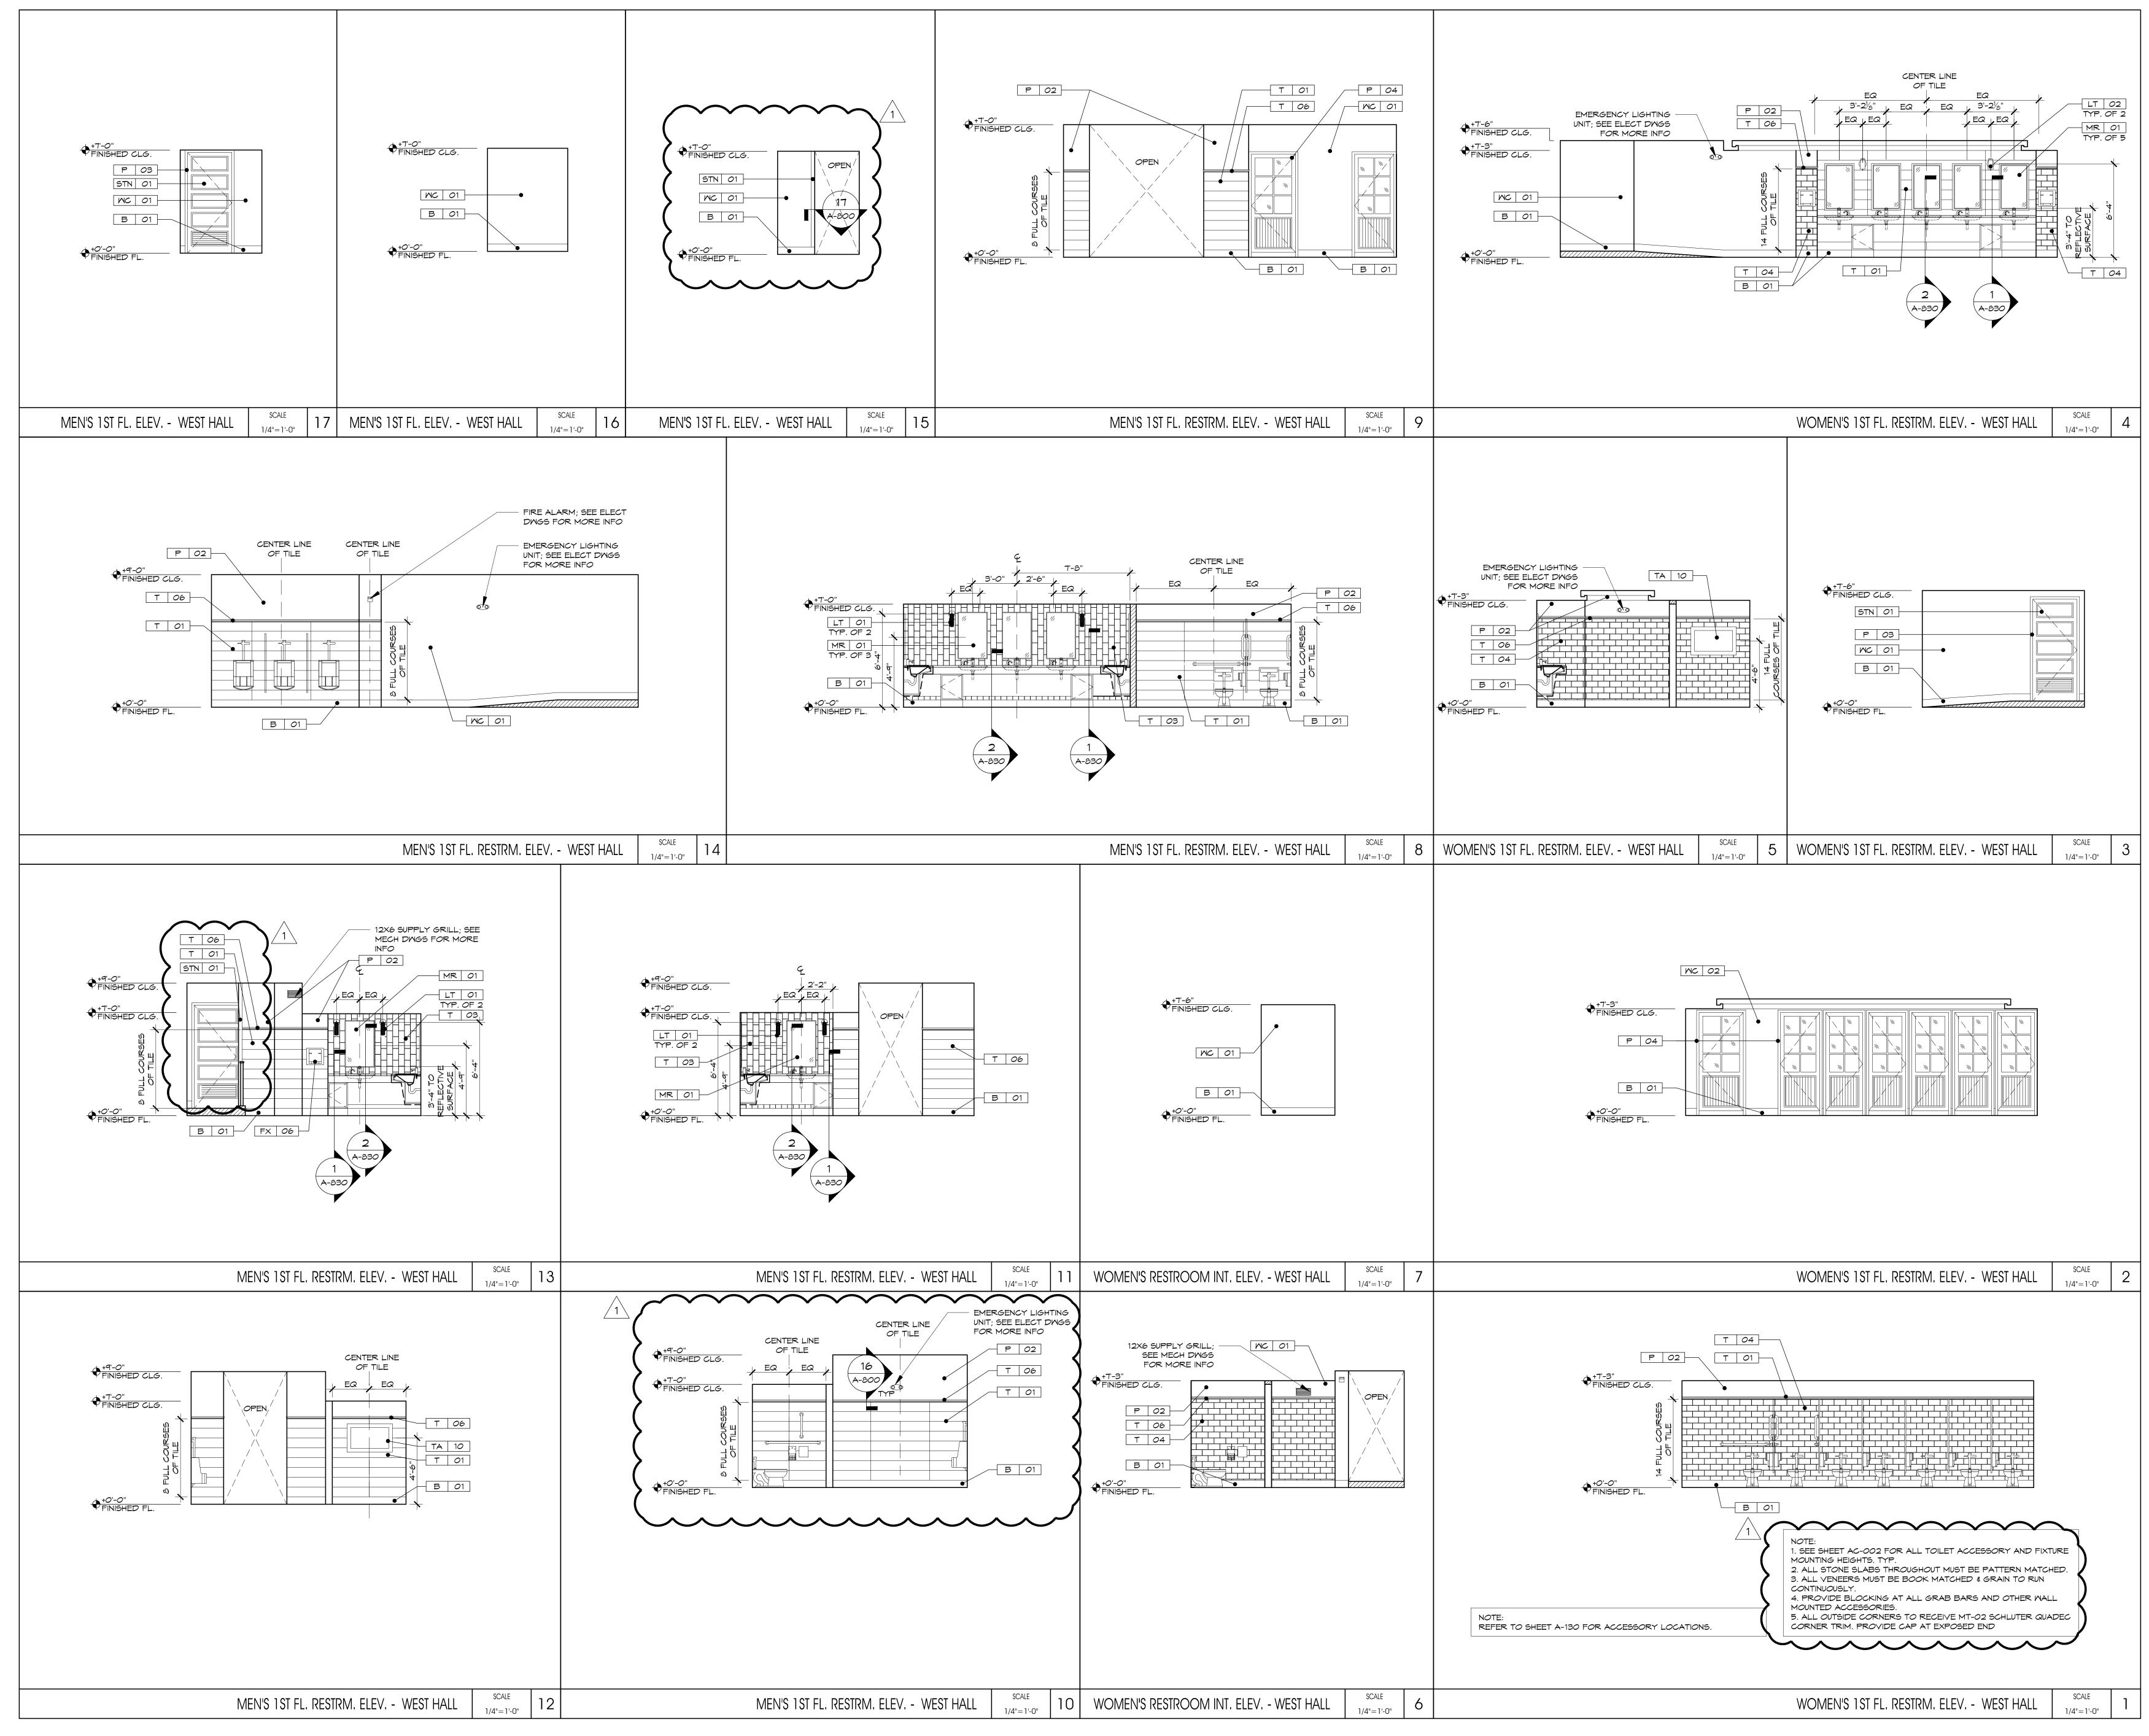


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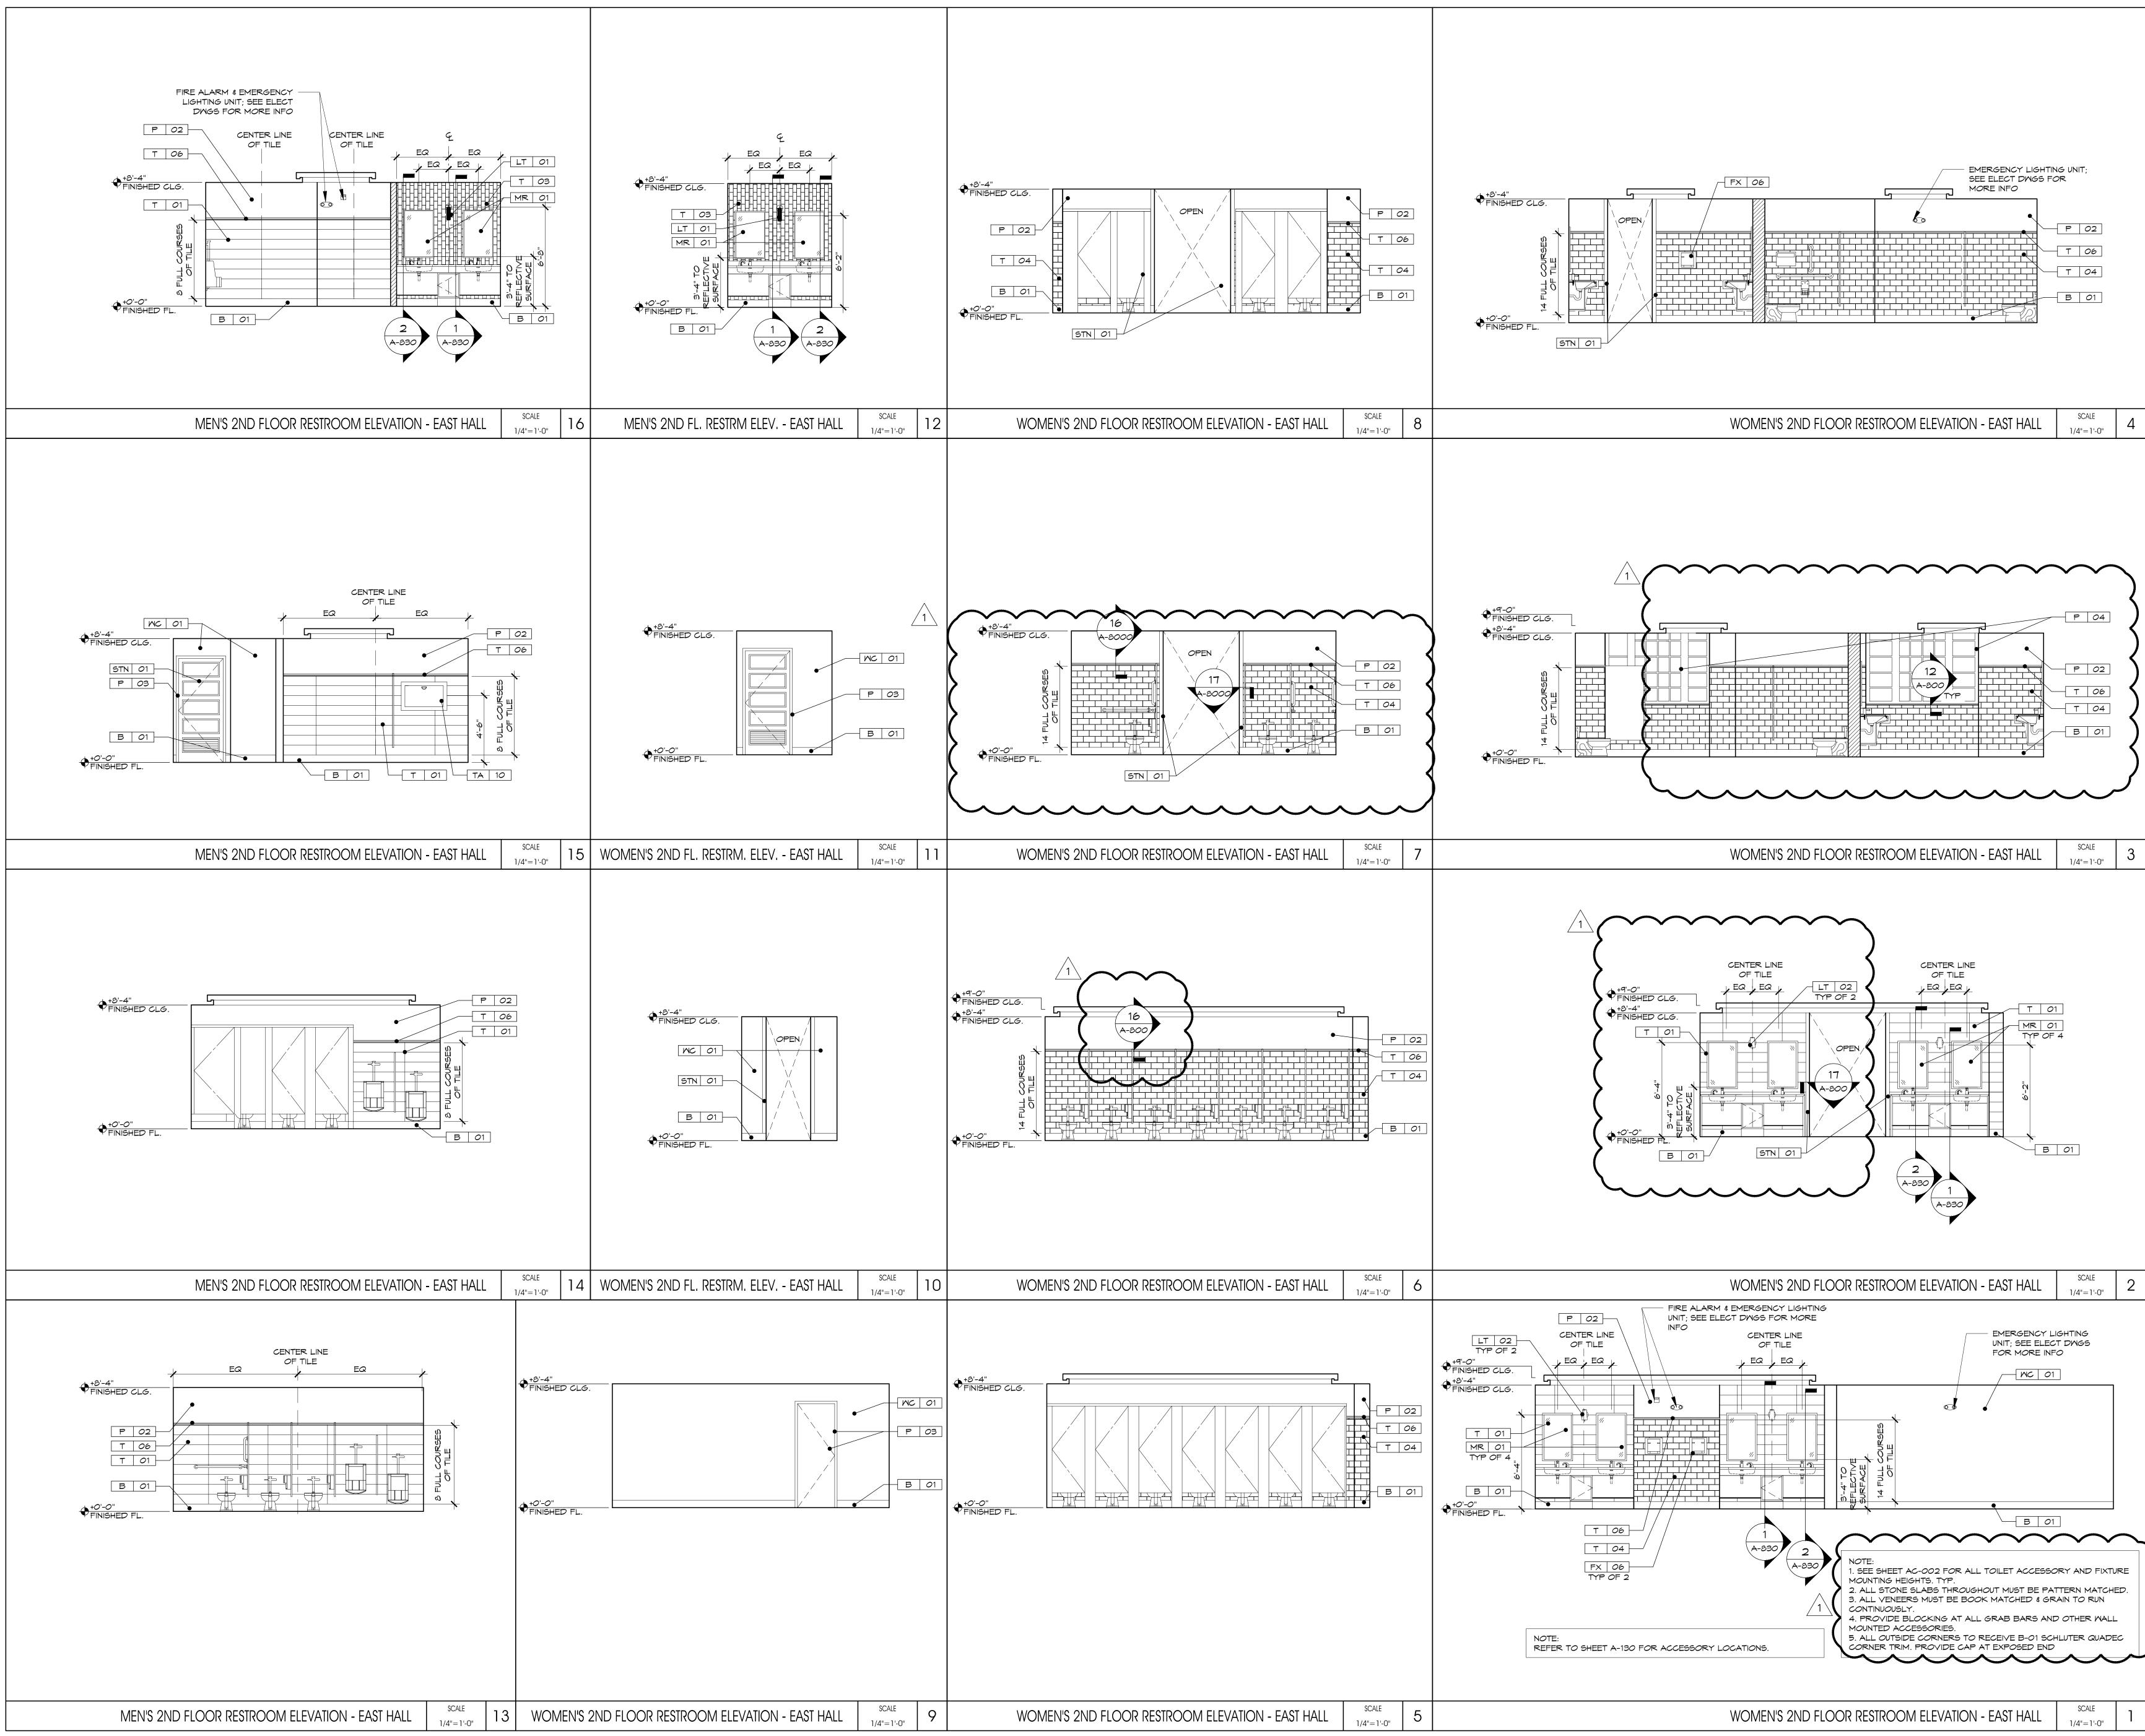




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 <u>1</u> 2016.11.30 ADDENDUM #2
I 10-14-2016 I CONSTRUCTION DOCUMENTS NO. I DATE: I DESCRIPTION:
DRAWING TITLE:
WOMEN & MEN'S 1ST FLOOR RESTROOMS - EAST HALL
DRAWN BY: SB DRAWING NO. REVIEWED BY: CM
PROJECT NO. 15243.00.001 A-600

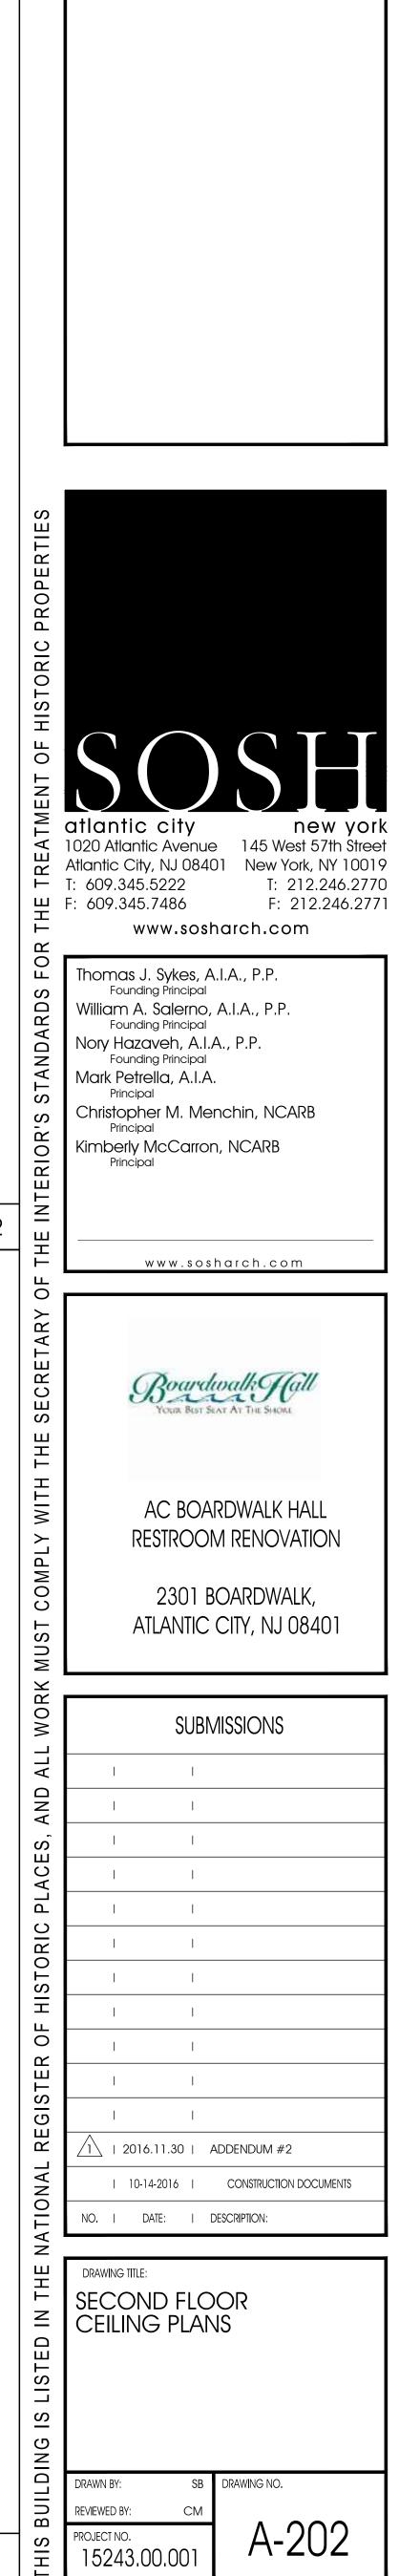


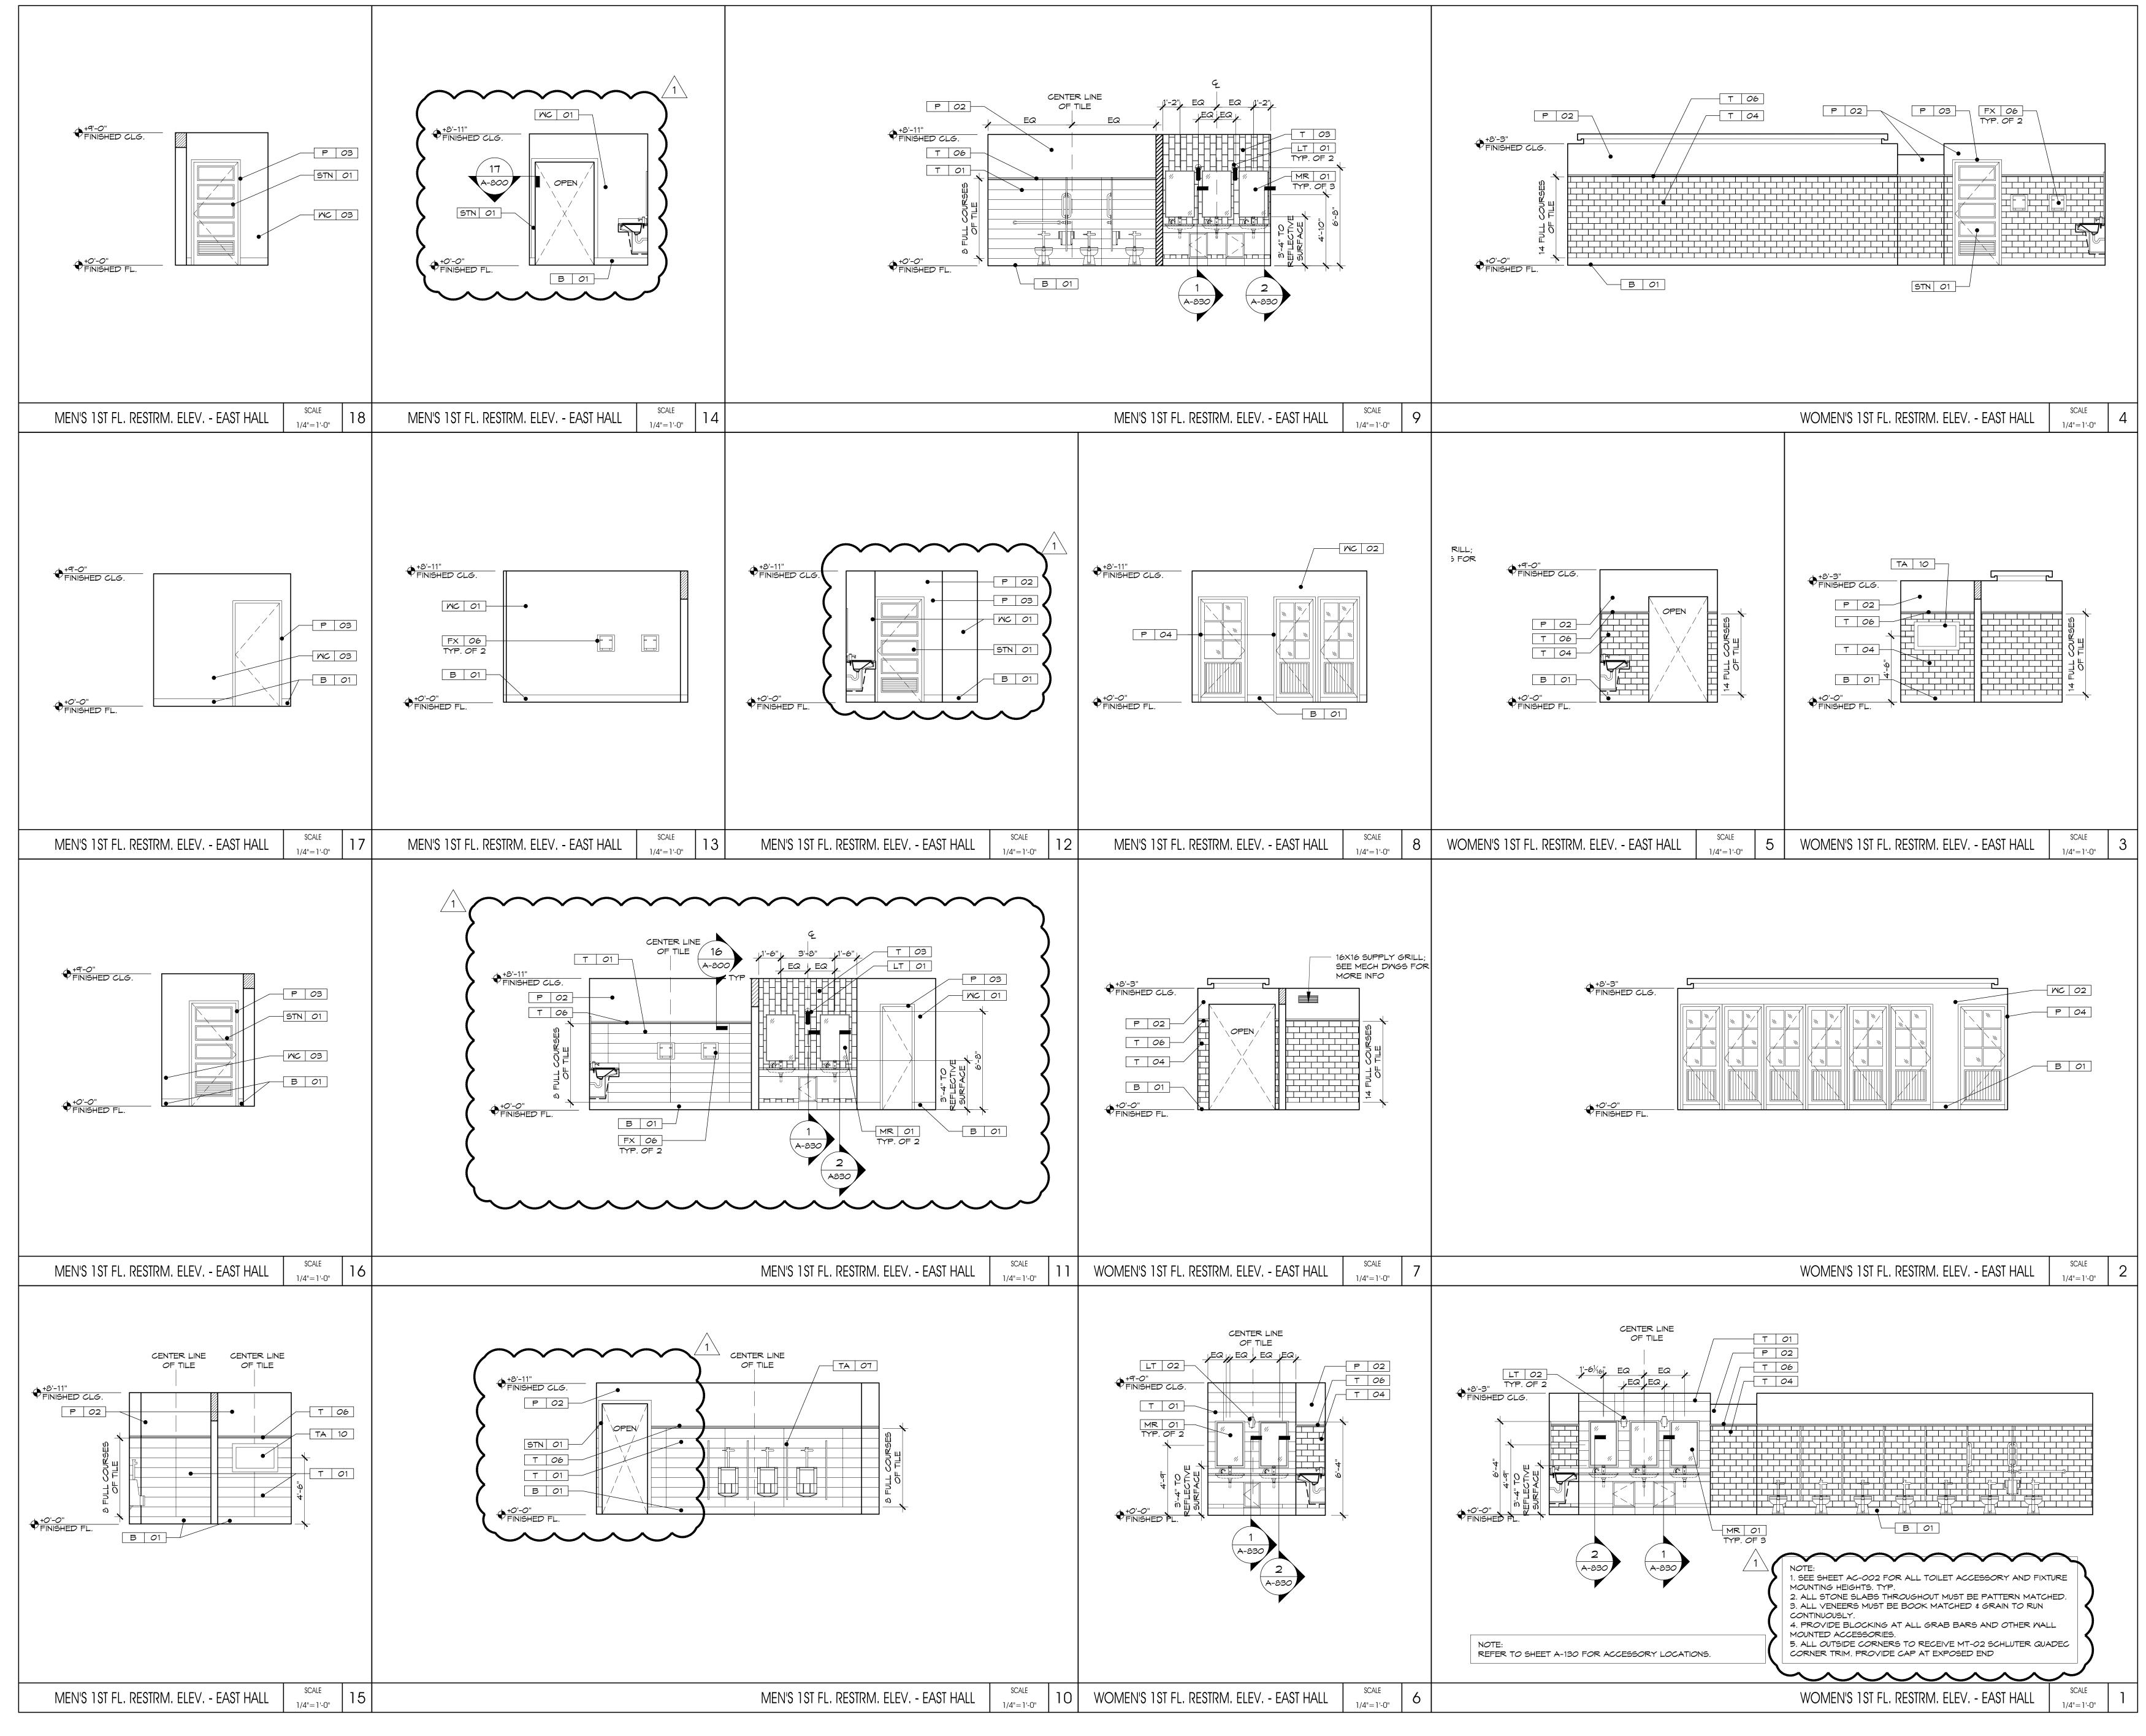
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1 + 2016.11.30 + ADDENDUM #2 + 10-14-2016 + CONSTRUCTION DOCUMENTS NO. + DATE: + DESCRIPTION: + -
DRAWING TITLE:
INTERIOR ELEVATIONS WOMEN & MEN'S 1ST FLOOR RESTROOMS - WEST HALL
DRAWN BY: SB DRAWING NO. REVIEWED BY: CM PROJECT NO. 150420001
15243.00.001 A-OUT





SolutionSolutionatlantic citynew york1020 Atlantic Avenuenew yorkAtlantic City, NJ 08401145 West 57th Street1: 609.345.5222145 West 57th StreetF: 609.345.74861: 212.246.2770F: 212.246.2770F: 212.246.2770www.sosharch.com
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NO. DATE: DESCRIPTION:
DRAWING TITLE:
DRAWN BY: SB DRAWING NO. REVIEWED BY: CM PROJECT NO. 15243.00.001 A-602


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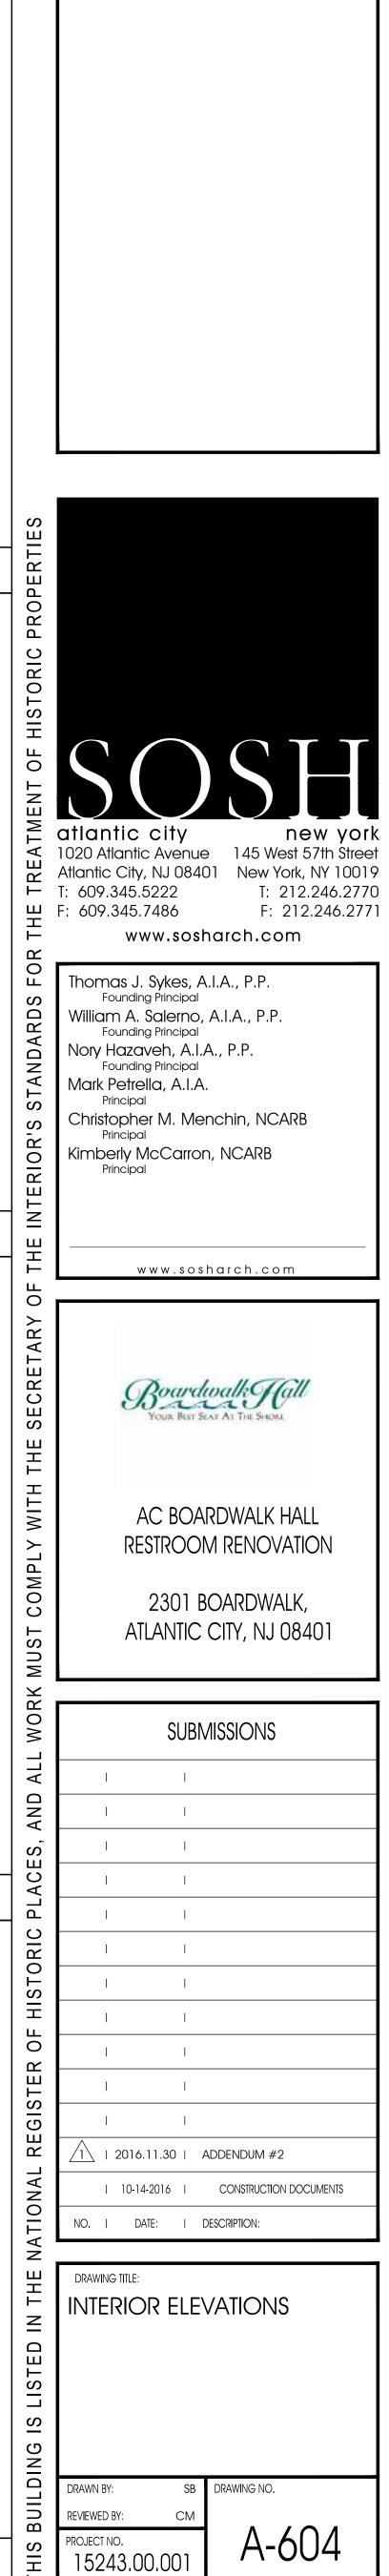


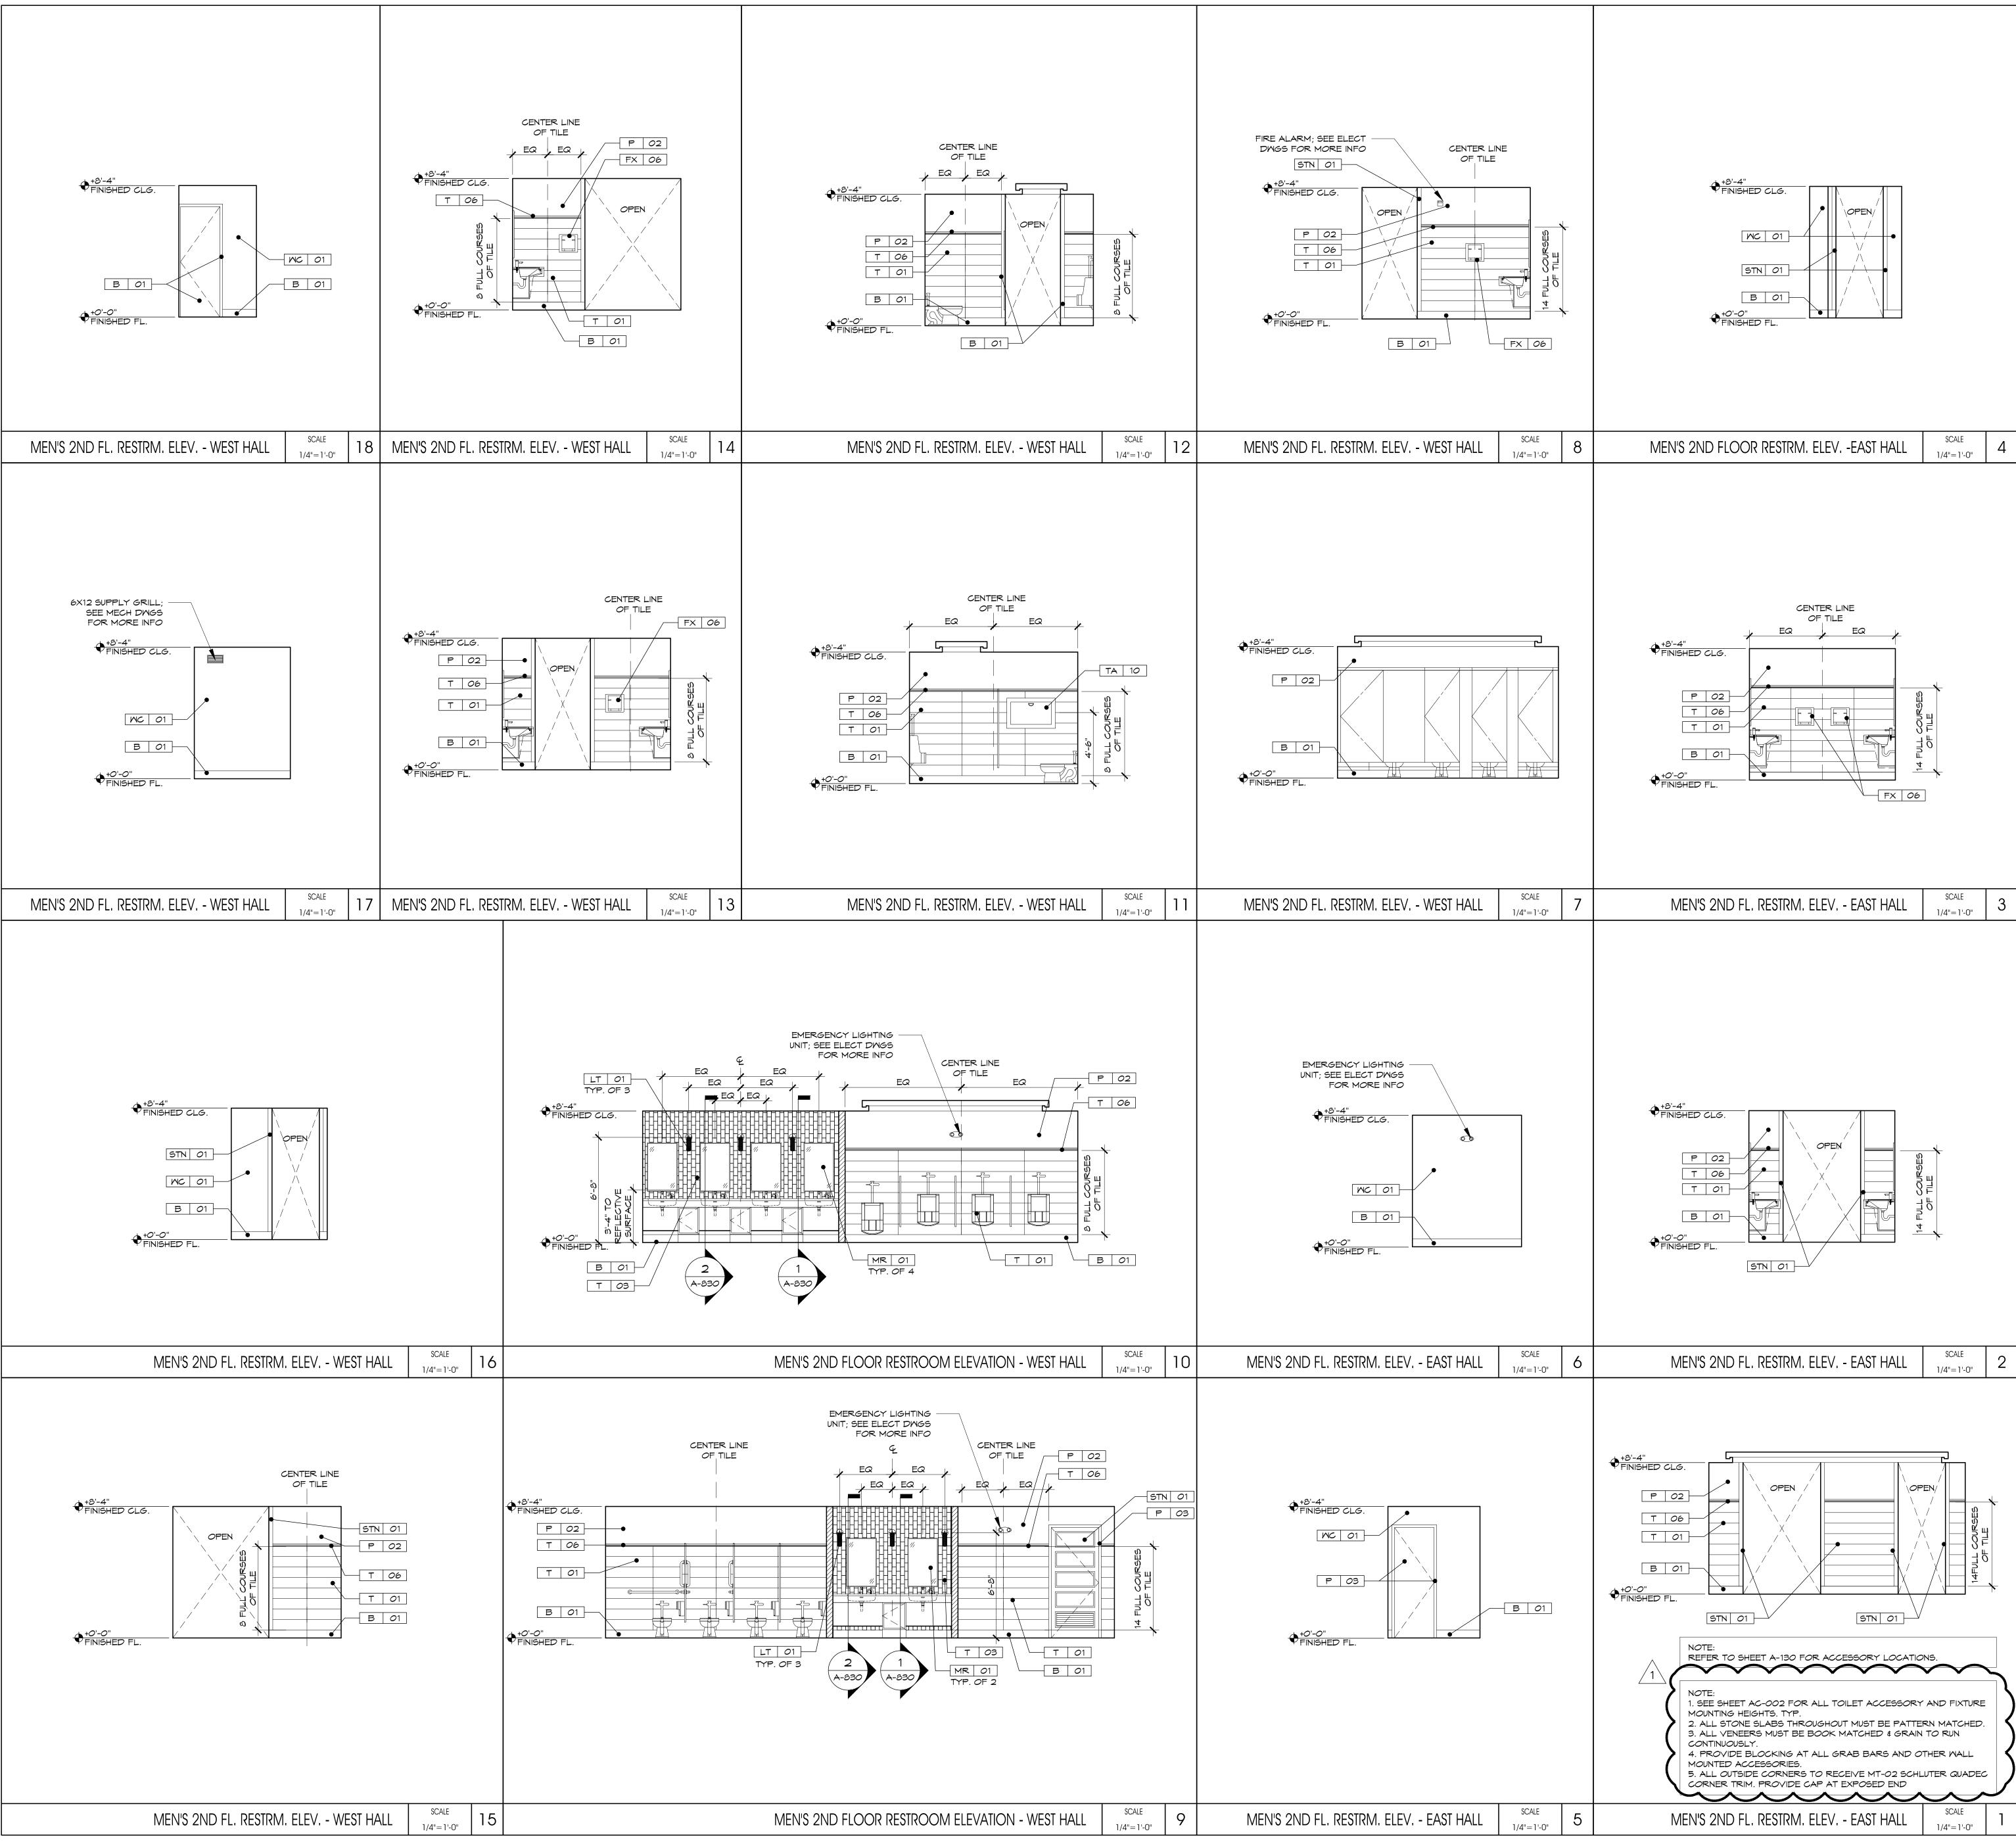


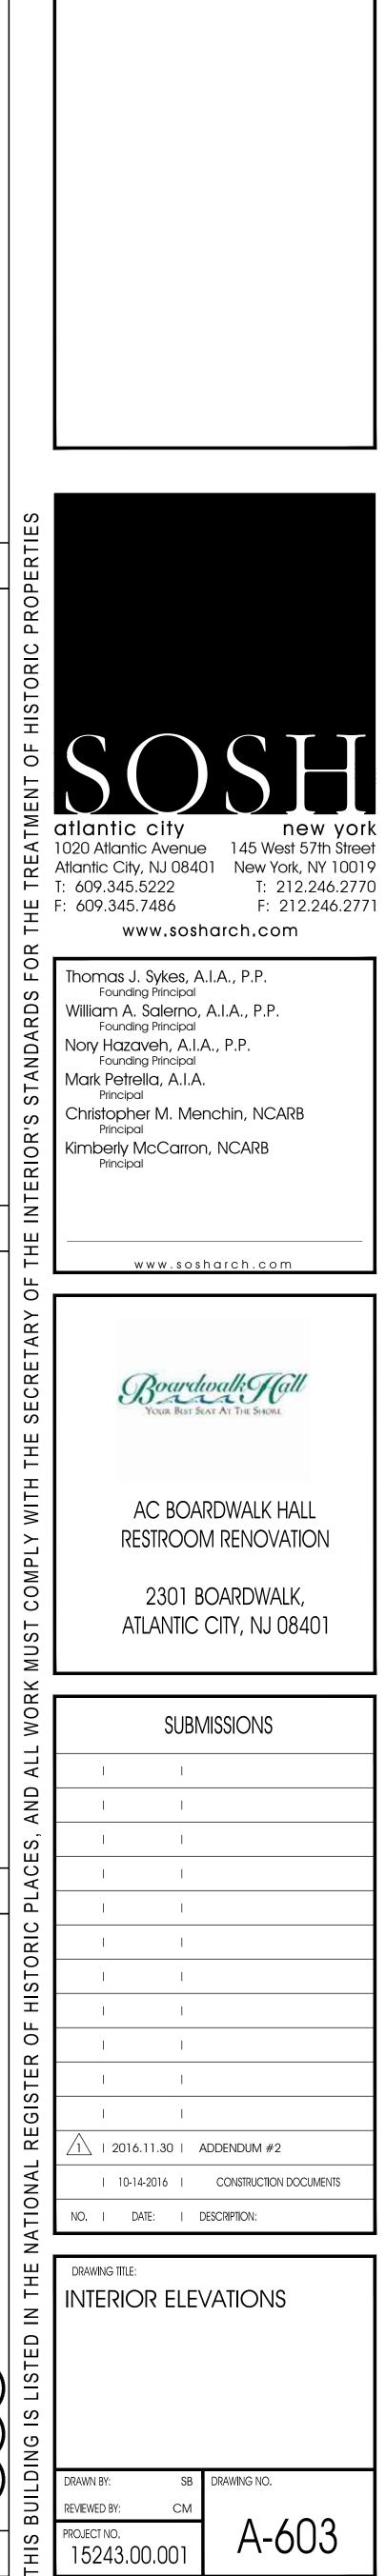

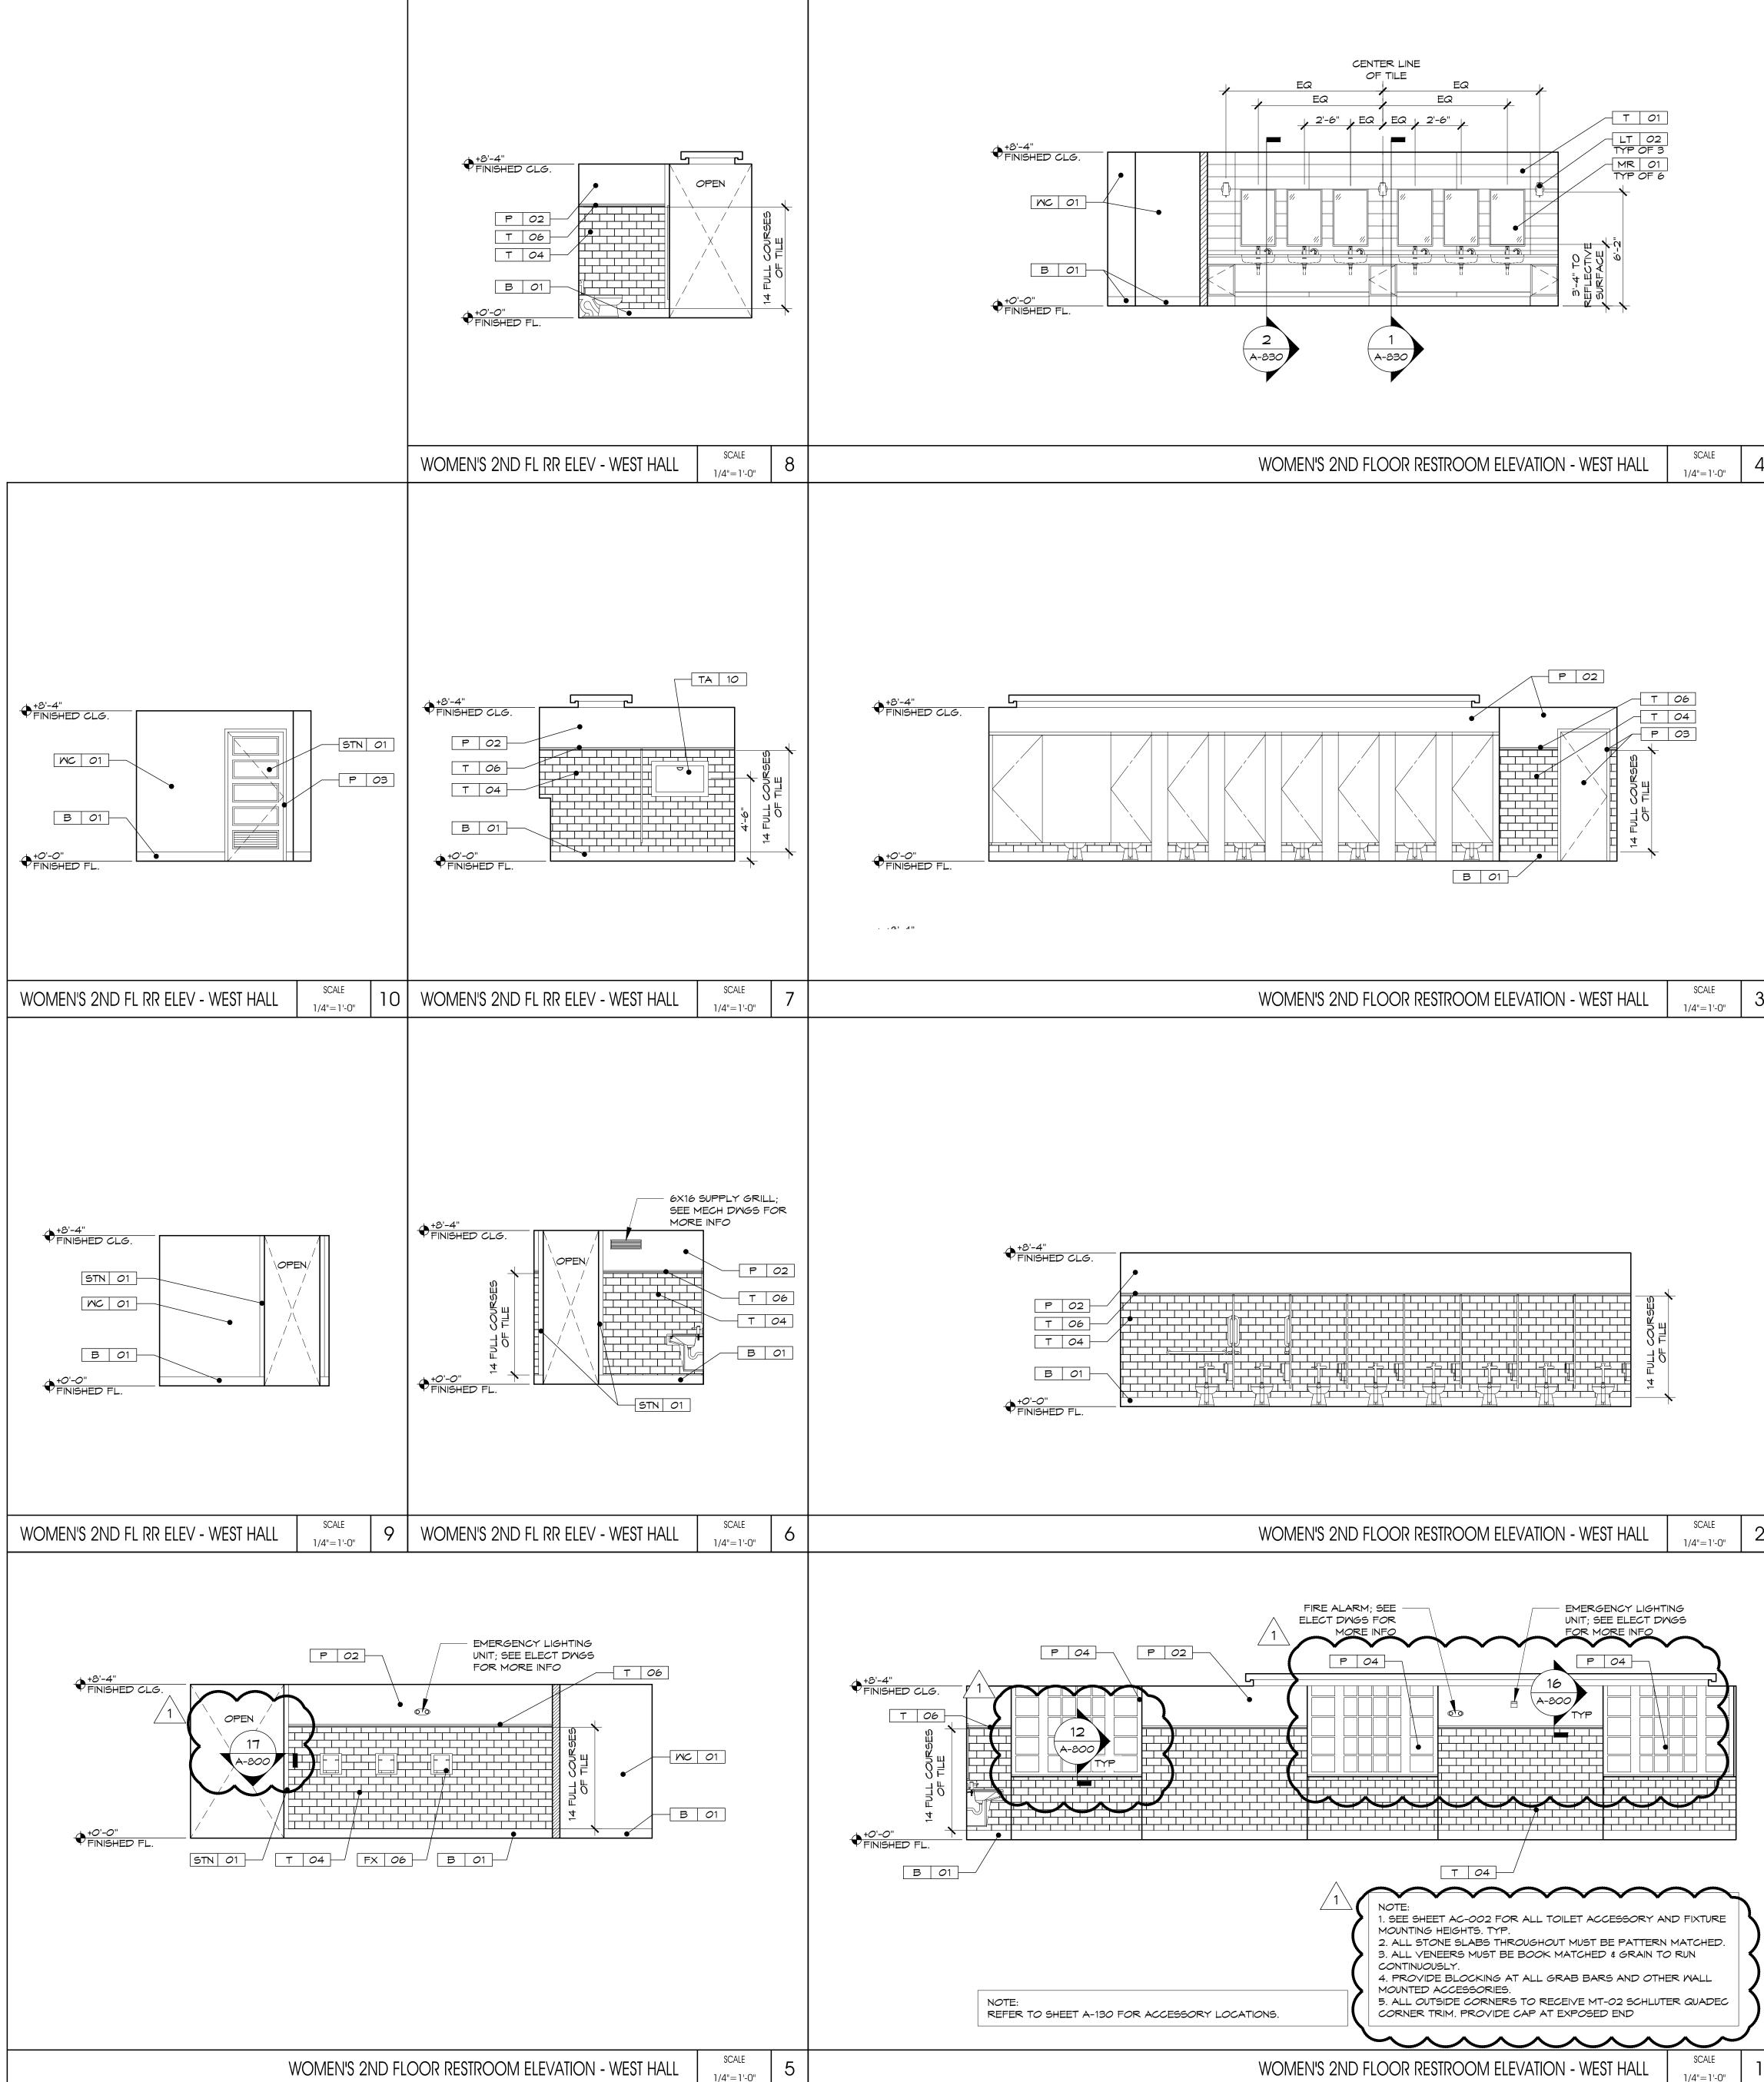

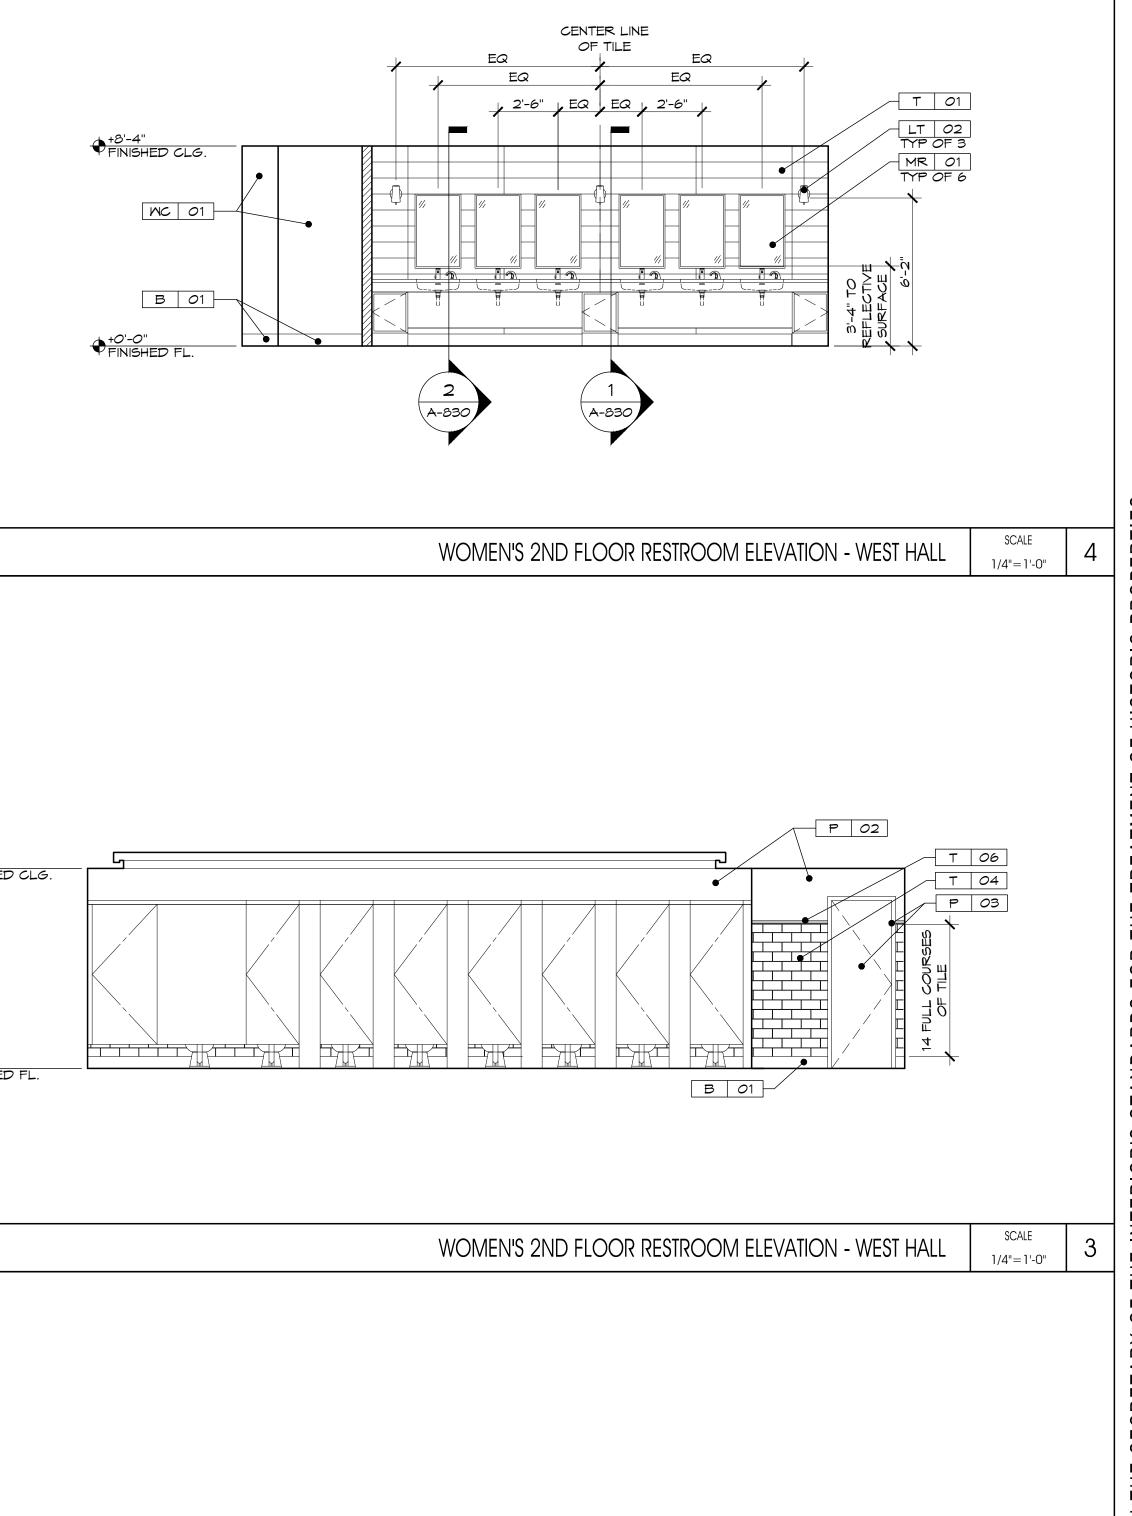

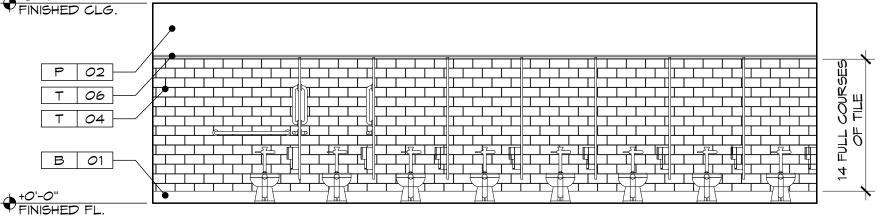

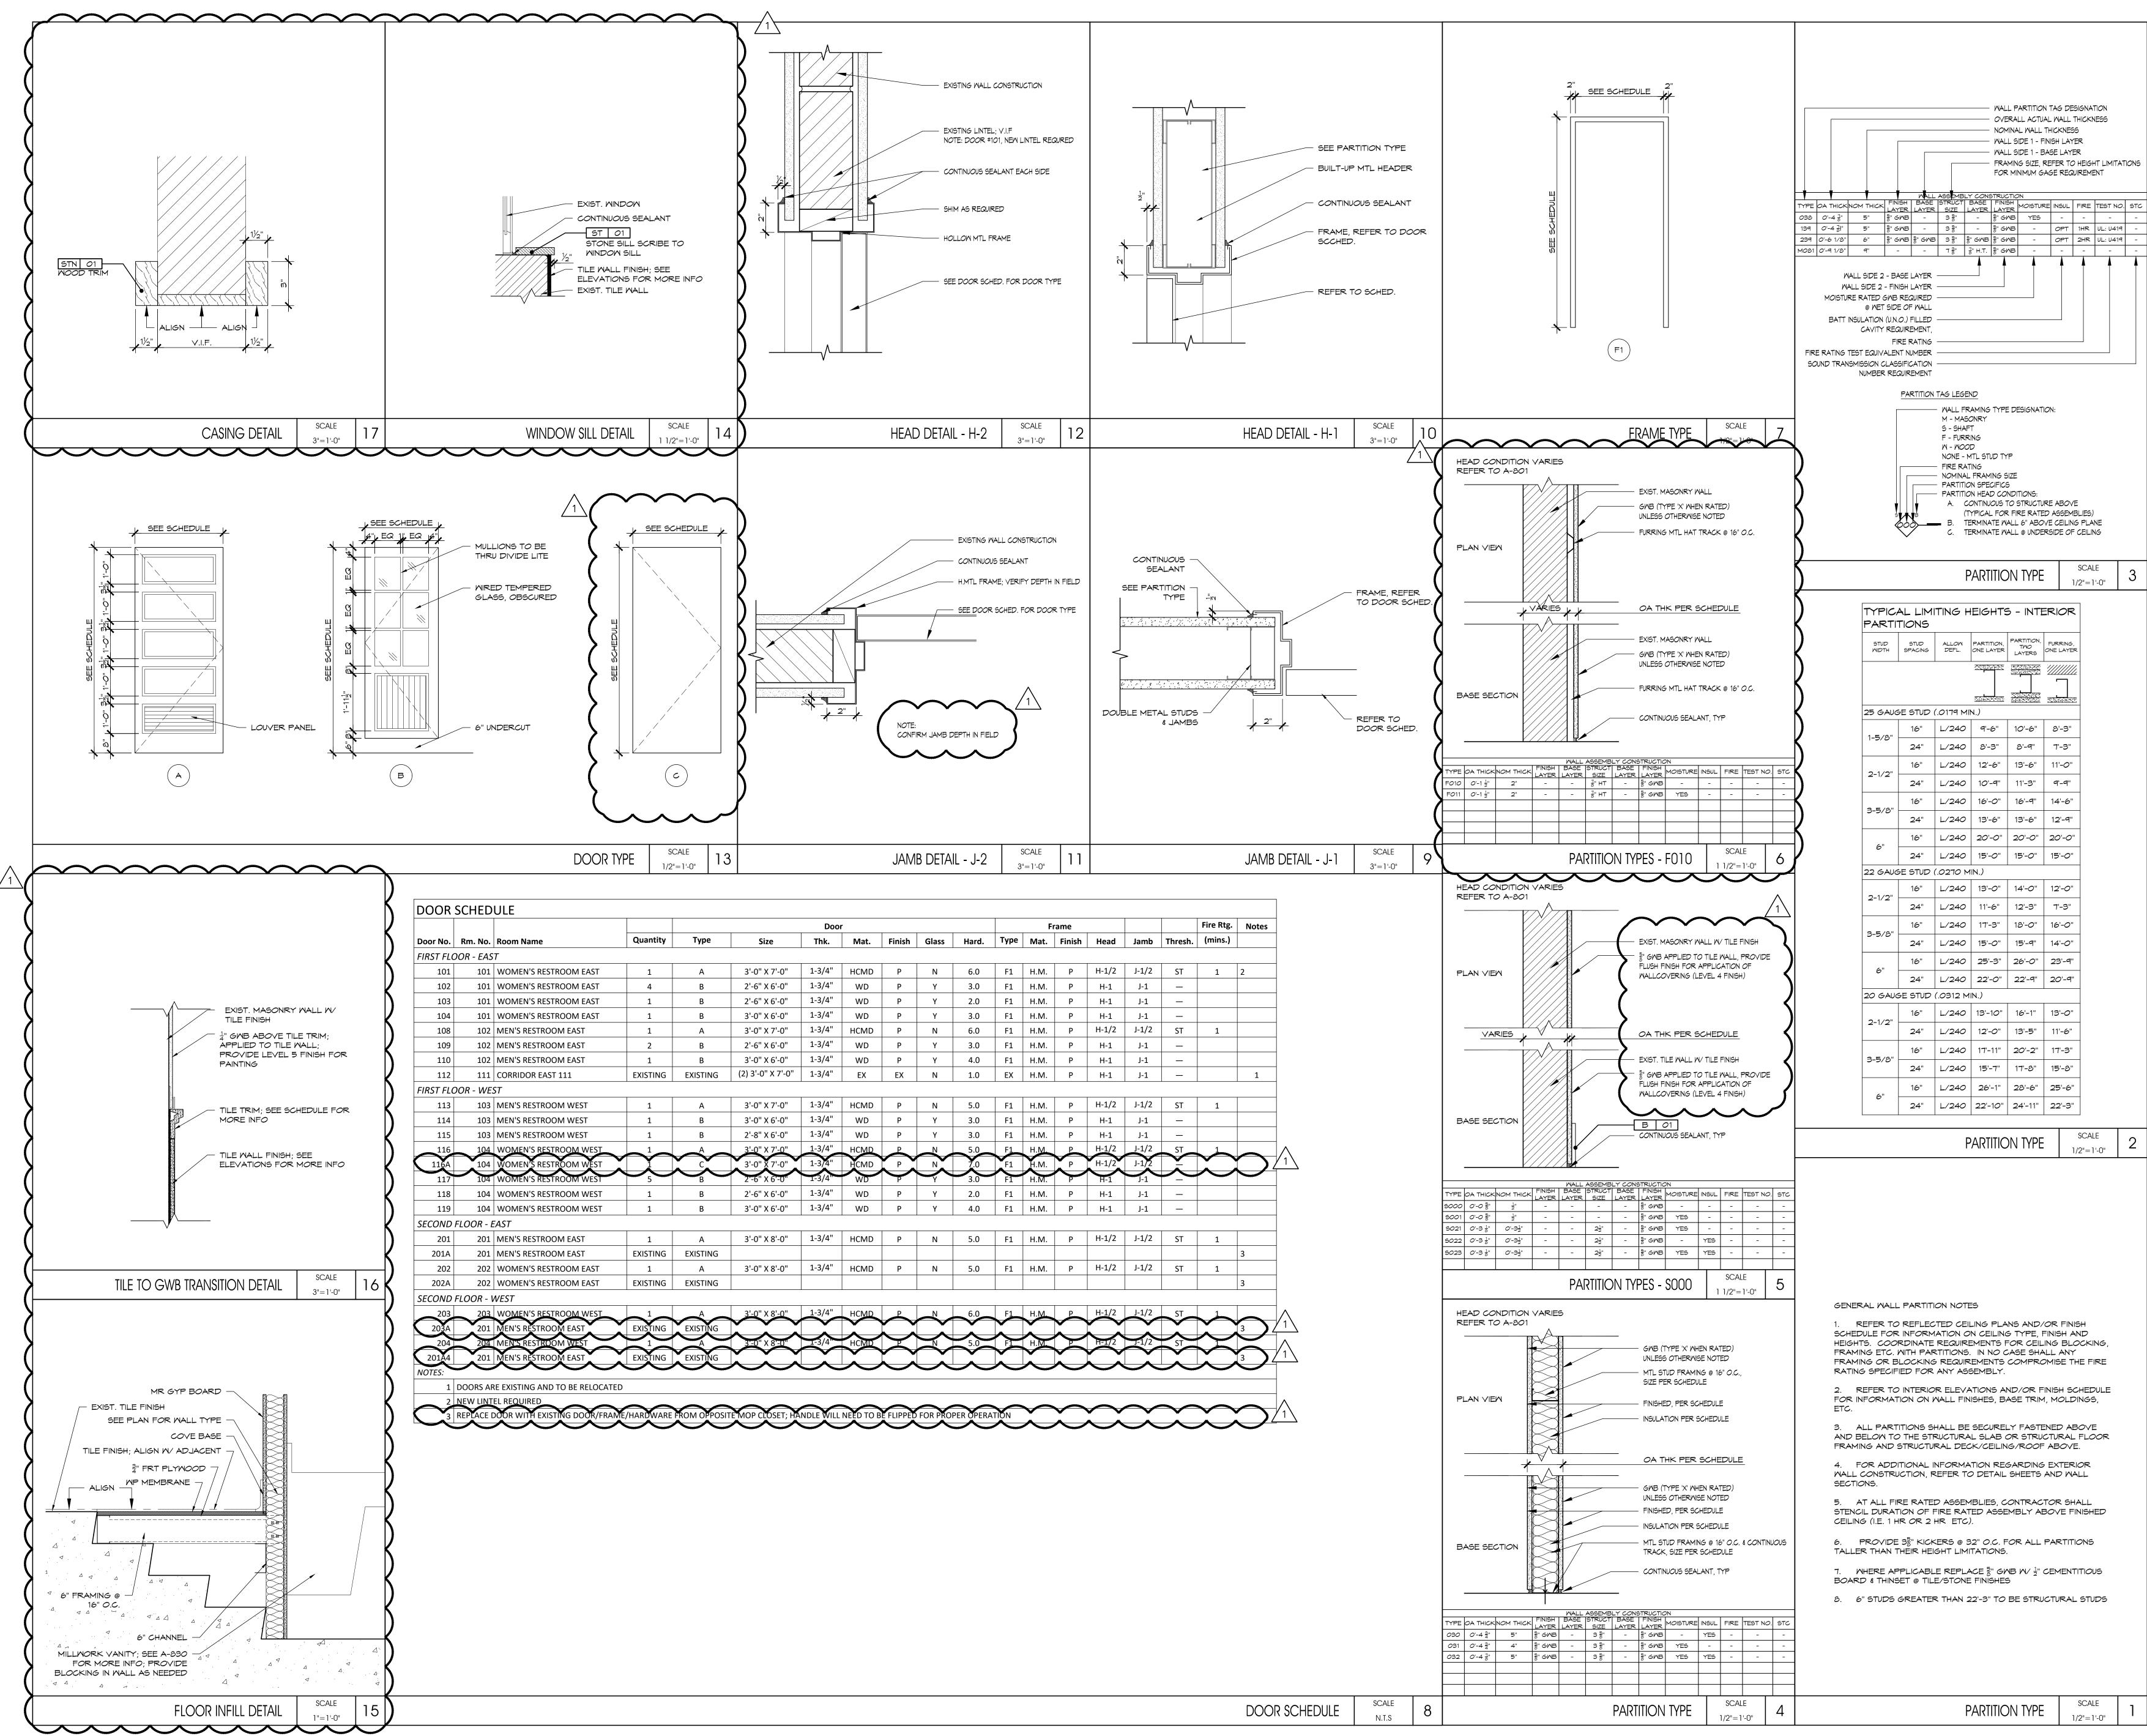

	Door						Frame						Fire Rtg.	Notes
Туре	Size	Thk.	Mat.	Finish	Glass	Hard.	Туре	Mat.	Finish	Head	Jamb	Thresh.	(mins.)	
А	3'-0" X 7'-0"	1-3/4"	HCMD	Р	N	6.0	F1	H.M.	Р	H-1/2	J-1/2	ST	1	2
В	2'-6" X 6'-0"	1-3/4"	WD	Р	Y	3.0	F1	H.M.	Р	H-1	J-1			
В	2'-6" X 6'-0"	1-3/4"	WD	Р	Y	2.0	F1	H.M.	Р	H-1	J-1			
В	3'-0" X 6'-0"	1-3/4"	WD	Р	Y	3.0	F1	H.M.	Р	H-1	J-1	_		
А	3'-0" X 7'-0"	1-3/4"	HCMD	Р	N	6.0	F1	H.M.	Р	H-1/2	J-1/2	ST	1	
В	2'-6" X 6'-0"	1-3/4"	WD	Р	Y	3.0	F1	H.M.	Р	H-1	J-1	_		
В	3'-0" X 6'-0"	1-3/4"	WD	Р	Y	4.0	F1	H.M.	Р	H-1	J-1	_		
XISTING	(2) 3'-0" X 7'-0"	1-3/4"	EX	EX	N	1.0	EX	H.M.	Р	H-1	J-1	_		1
					•						•			
А	3'-0" X 7'-0"	1-3/4"	HCMD	Р	N	5.0	F1	H.M.	Р	H-1/2	J-1/2	ST	1	
В	3'-0" X 6'-0"	1-3/4"	WD	Р	Y	3.0	F1	H.M.	Р	H-1	J-1	_		
В	2'-8" X 6'-0"	1-3/4"	WD	Р	Y	3.0	F1	H.M.	Р	H-1	J-1	_		
A	<u>3'-0" X 7'-0"</u>	1-3/4"	HCMD	Р	N	5.0	F <u>1</u>	H.M.	Р	H-1/2	J-1/2	ST	1	
C	3'-0" X 7'-0"	1-3/4"	HCMD	Р	N	7.0	F1	H.M.	Р	H-1/2	J-1/2	Y		\square
B	2'-6" X 6'-0"	1-3/4"	WD	P	Ý	3.0	F1	H.M.	P	H-1	J-1		\sim	\sim
В	2'-6" X 6'-0"	1-3/4"	WD	Р	Y	2.0	F1	H.M.	Р	H-1	J-1	_		
В	3'-0" X 6'-0"	1-3/4"	WD	Р	Y	4.0	F1	H.M.	Р	H-1	J-1	_		
·						•					•			•
А	3'-0" X 8'-0"	1-3/4"	HCMD	Р	N	5.0	F1	H.M.	Р	H-1/2	J-1/2	ST	1	
EXISTING														3
А	3'-0" X 8'-0"	1-3/4"	HCMD	Р	N	5.0	F1	H.M.	Р	H-1/2	J-1/2	ST	1	
EXISTING														3
									•					•
A	<u>3'-0" X 8'-0"</u>	<u>1</u> -3/4"	HCMD	Р	N	6.0	F <u>1</u>	Н. <u>М.</u>	P	H-1/2	J-1/2	ST	1	
EXISTING														3
	<u>3'=0" X 8'=0"</u>	1-3/4"	нсмр			5.0	FI	H.M.		H-1/2	J-1/2	ST		\leq
							\sim	\sim						

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DRAWING TITLE: WALL PARTITION TYPES
HEIGHT LIMITATION CHART PARTITION LEGEND
DRAWN BY: SB DRAWING NO. REVIEWED BY: CM PROJECT NO. 15243.00.001 A-800